PARKS, TRAILS, AND OPEN SPACE COMMITTEE SEPTEMBER 3RD, 2019 6:00 PM TOWN HALL



Committee Member Meeting Packet

Agenda Item #2:

PARKS, TRAILS, AND OPEN SPACE COMMITTEE MEETING MINUTES MAY 7TH, 2019 6:00 PM TOWN HALL



Committee Present: Jared Coburn, Doug Canright, Mayor Pro Tem Eric Johnson, Town Councilor Robb Austin.

Town Staff: Chase Jones

- I. Call to Order: 6:09pm
- II. Approval of meeting minutes from March 5th, 2019

 Jared moved to approve the minutes

 Robb seconded the motion

 All committee members present voted in favor
- III. Review upcoming public events

 Chase shared all scheduled town events occuring before the next committee meeting on July 2nd 2019.
- IV. Chamber Heritage improvements and RFP

The committee discussed the 'Colorado Main Street – Request for Proposals for the Ridgway Heritage Park and Visitor Center Construction and Bid Documents' and developed the following comments:

- The project would likely be ideal for a GOCO grant
- In the height of ski season there are roughly 30 cars per day parking at that location
- Consider moving the landscaping strip to the middle to help maximize parking spaces
- Recommend to maximize parking
- Certain members were not in favor of the larger tourist oriented structures, such as the "picture frame", but acknowledged there is a vistitors center so there will need to be a balance between providing for local residents and tourists.
- Incorporating Ute and Native American history should also be explored

Chase was to share the above comments with those involved. With the chamber having \$5,000 and the Main Street Development group having \$5,000 for improvements during 2019, there will likely not be enough funding for all improvements.

V. New Business

Ridgway Community Garden - Jared shared a brief update of the garden with the following being completed; fencing, gravel parkings lot, irrigation and the raised beds are being prepped. Opening day is scheduled for May 18th and a shade structure is planned to be built later in the summer. Jared thanked Town staff and the Public Works Department for their assistance in the project.

Sue Husch - The Committee recommended the appointment of Sue Husch to the Parks, Trails and Open Space Committee due to her interest and community involvement. The recommendation will be taken to Town Council during their next regular meeting for approval.

Tree funding – Eric suggested that the committee consider requesting twice the current annual budget for arborist work with annual increases from Town Council during the next budget season.

Trails near Solar Ranch – Doug inquired what trails will be regraveled during the planned 2019 trail work in Cottonwood Park. Chase is to discuss with other staff, review initial scope of work and funding limitations then return to the next meeting with an answer.

VI. Old Business

The committee was updated with the following information:

- Picnic Tables 22 new, 6 are ADA, tables are in each place committee prioritized previously
- Planting trees 10 trees have been replaced, will get second order in when number is finalized
- Seasonal hires 1 hired already, 2^{nd} to start the 20^{th} of May 2019
- Streetscape contract maintenance contract has been renewed for 2019
- Pickleball staff is working with contractor to set date to strip pickleball lines on the tennis court.
- Harmony Park the ground beneath the instruments has been wood chipped. This work completed the project.

VII. Adjourn *6:59pm*

Agenda Item #3:

Agenda Item #4:

<u>Sept 2nd to Nov 5th, 2019 Events on Public Parks Property:</u>

May 24 to Oct 11 – Farmer's Market in Hartwell Park every Friday

Sept 20 – Private kick-ball in Athletic Park

Sept 21 – Wedding in Dennis Weaver Memorial Park

Oct 5 – Dennis Weaver Park Plein Air Contest

Oct 5 – ROK'N Run and Potluck in Hartwell

Oct 11, 12, 13 – Old West Fest

Agenda Item #5:



Chase Jones

From: H <ridgwaycounseling@gmail.com>

Sent: Friday, June 28, 2019 3:28 PM

To: Chase Jones
Cc: Josephine Scoville

Subject: Parks Committee Meeting

Dear Chase,

I would like to follow up on our conversation earlier this summer regarding the Solar Ranch Baseball field. As you know our youth baseball program has over 50 youth participating, the majority live in the Ridgway zip code. Currently only our Tball teams practice in Ridgway due to the condition of the Ridgway Baseball Field.

On Tuesday myself and fellow volunteer Tball coach and parent Josephine Scoville would like to encourage the committee to begin to budget for the development and upkeep of this field. I have had preliminary conversations with a member of the parks and rec committee in Ouray who assists in the maintenance and budgeting of the Baseball field in Ouray. I am awaiting their budget in writing. Without seeing the condition of the Ridgway field this member believes it may take an initial \$8,000-\$10,000 to get the field up to standards and a much smaller budget of \$2,000-\$3,000 annually or every other year to maintain it once it is established with proper soil. I also have a call into Soccer Director Dalton Carver to start talking about sharing the fields with baseball teams. I believe the seasons do not cross dates and if perhaps they did we could still have soccer and baseball going on at the same time.

It is so fun to watch the kids in their baseball uniforms play! We have been obtaining citizen support in the way of a signatures to show interest and I am sure if this was put in motion could gather volunteers of all sorts to aid in the development of the field.

I look forward to gathering more details to share with you and look forward to speaking more on Tuesday.

Sincerely,

Helene "H" Discoe 970-318-8537

Sent from Mail for Windows 10

We the undersigned request the Town of Ridgway, Parks and Rec Department to create an annual budget line item to improve and maintain the Solar Ranches Baseball Field. This year we have over 50 youth participating in Ouray County Baseball teams. The majority of participants reside in the Ridgway zip code. Due to fact there is no maintained baseball field in Ridgway to safely play on, only the Tball teams can practice in Ridgway because they do not require a formal field. In addition, 4 out of the 7 coed Softball teams who play in Ouray are Ridgway zip code residents. As town and county residents, volunteers, parents, students and Baseball advocates we urge you to consider supporting the growing interest our youth and community have in baseball. Thank you for your consideration.

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Agenda Item #6:

Chase Jones

From: Rick Weaver <rweaver2401@gmail.com>
Sent: Wednesday, July 24, 2019 12:57 PM

To: Chase Jones

Subject: Weaver Park Signs Request

Attachments: Signs Template.pdf

Categories: Parks

Chase -- pursuant to our recent conversation at the Parks/Trails Committee meeting, I am requesting that the Committee ask the Town Council to include in its upcoming budget the cost of replacing the 10 deteriorating wood trail signs in the Dennis Weaver Memorial Park with similar looking, maintenance-free metal signs. To that end, I am including here some supporting material: photos and an attached PDF template. The estimate from the sign company to replace all 10 signs is \$575 + tax.

First, here is the current poor condition of the most important trail sign, which I believe does not reflect well on the Park or my father's legacy. The maintenance cost on this and all wood signs will only increase and recur if they are not replaced.



Here is an example of a metal sign that has been out there since about 2010 and still looks good.



Side by side comparison of current wood and proposed new metal, maintenance free sign:



Attached below is a template for all 10 new signs -- again, the estimate from In Design Signs is \$575 + tax. I think this is a good deal - we are getting a discount as a repeat customer. We would prefer that the Town install them, but RiverSage could also do it.

Finally, at the meeting I suggested a new sign next to the sign below on the fence that would read: **PARK CLOSED AT DUSK** - I would pay for and install this one. Please ask for Council Approval for this.



I appreciate your moving this request on to Town Council for consideration in their next budget. If you have any questions, please let me know or call at 970-275-8866. Thanks again.

Rick Weaver

















STAGECOACH TRAIL

TC



.3 MI .4 MI 1 MI

THIS PARK IS A WILDLIFE CORRIDOR
PLEASE...STAY ON TRAILS
USE AT YOUR OWN RISK
LEASH AND CLEAN UP AFTER DOGS

THANKS!

RIDGWAY'S BOOT HILL SUMMIT

HIGHEST POINT IN THE PARK
LOWEST POINT FOR THE
VARMINTS BURIED HERE

COURTESY OF MARSHAL MATT DILLON WITH A LITTLE HELP FROM CHESTER

Agenda Item #7:

Chase Jones

From: Vicki Hawse <vickihawse@gmail.com>

Sent: Friday, June 28, 2019 11:04 AM

To: Chase Jones **Subject:** Re: Water for Dogs

Vicki Hawse

vickihawse@gmail.com

Here are the photos Chase,

The idea is to build a cement basin beneath the existing fountain with a water source to fill it. Thanks,



On Jun 28, 2019, at 10:40 AM, Chase Jones < cjones@town.ridgway.co.us > wrote:

Morning Vicki,

Great thank you, I will look for the photos/examples shortly. The meeting starts at 6pm Tuesday July 2^{nd} in Town Hall. There will be topics and requests in front of you on the agenda so if you're a little late you should be fine. I can email you the agenda this afternoon.

Best, Chase

From: Vicki Hawse < vickihawse@gmail.com >

Sent: Friday, June 28, 2019 10:32 AM

To: Chase Jones < cjones@town.ridgway.co.us >

Subject: Re: Water for Dogs

Hi Chade,

So sorry, I just got this. I will go down right now to get you some photos. I finish work on the 2nd at 5:30, what time is the meeting? Will send pics ASAP Much gratitude,

From: Pam Kraft
To: Chase Jones

Subject: FW: Dog Trough for Athletic Park **Date:** Monday, July 1, 2019 11:18:35 AM

From: Mitzi Mallard [mailto:mitzimallard@gmail.com]

Sent: Monday, July 01, 2019 11:14 AM **To:** Pam Kraft <pkraft@town.ridgway.co.us>

Subject: Dog Trough for Athletic Park

Hello Pam,

I hope you are having a good day. Unfortunately, I will be unable to attend the meeting tomorrow evening, however, I would like to express my support for a water trough for dogs at Ridgway's Athletic park. We feel fortunate to have such a wonderful park where we are able to enjoy a nice open space for ourselves, as well as our dog. For a while, there was a dog dish that someone voluntarily provided near the water fountains, however, it has since disappeared and something more permanent would be a nice addition.

Thank you for your time and consideration.

Mitzi Mallard 970-209-1431

Agenda Item #8:

Chase Jones

From: Deanna Drew

Sent: Wednesday, August 28, 2019 10:50 AM

To: Chris Hawkins- OCSA; Dalton Carver- OCSA; Donna Clark - pickleball; Doug Canright; Gordon

Reichard- pickleball club; Jack Young- Chipeta; Kristine Coughlin; Larry Falk; Michael Cox - The Preserve; OCB (ouraycountybaseball@gmail.com); Patsy Young; Rodney Fitzhugh - RAT; Shane

Carrick- skatepark; Spencer Skatepark

Subject: Pavilion Fundraising!

Attachments: 8.5x11 Perk Up the Park.pdf; NOTE CARD Perk Up the Park x4.pdf

Categories: Parks

Greetings Athletic Park Stakeholders,

At our last meeting, we discussed a project the Town of Ridgway is taking on to build a new pavilion at the Ridgway Athletic Park. In lieu of a meeting, we are writing with this project update and a call to action for the fundraising phase of the project.

As you may recall, this pavilion will provide shelter, a concession area and equipment storage for park users and sports teams. However, the overall intent of the pavilion is to serve the community at large and have as broad and frequent use as possible to enhance the public's experience at this park.

The Request for Bids from design professionals, including the estimated project timeline, is now posted on the Town website here. The chosen design professionals will be required to engage with you as stakeholders, and utilize public input to inform the overall pavilion design.

The Athletic Park Pavilion Project is being funded by a 3 to 1 match up to \$300,000 from a generous anonymous donor, and the Town has committed to raise at least \$100,000 in cash and in-kind contributions from the community. As discussed, we are relying on your organization as a frequent user of the park, to help us generate the donations to meet this goal before the end of the year.

We have attached an 8.5 x 11 flyer and postcard-size hand out about the fundraising campaign, which can be attached or embedded in an email to your group or handed out. While it does not have a sketch of the potential pavilion at this time, we can prepare new materials once we get a conceptual design or designs. If you want hard copies, just let us know. Please share with us your organization's general fundraising plans and needs for additional fundraising tools, if any. Also, feel free to reach out to the other organizations that we talked about at the June meeting, like other regional groups that use the Athletic Park. Town staff will promote the campaign using the website, newsletters, utility bills, social media, newspapers and by word of mouth.

As you help fundraise, know that cash or check donations will now be accepted at Town Hall, and bank transfers or card payments may now be made online through the project page on the Town's website here. Additional information about the new pavilion, as well as ongoing project updates, can be found on this webpage for the duration of the project.

Your support is critical to the success of this project. If you have questions or would like more information about the project before launching your team's fundraising efforts, please call, email, or schedule a time to meet with Town staff that is convenient for you. If you feel another meeting between stakeholders would be valuable at this juncture in the project, just let us know and we will do our best to schedule a time that will accommodate everyone's busy schedule.

We will be monitoring the project fundraising through the fall and providing the group with regular updates on our collective progress via email. The Town of Ridgway thanks you in advance for your involvement with the new Athletic Park Pavilion. Your feedback, comments and suggestions are always welcome!



Deanna Drew Planning Assistant

RIDGWAY TOWN HALL
PO Box 10 | 201 N. Railroad Street | Ridgway, Colorado 81432
970.626.5308 ext. 223 | ddrew@town.ridgway.co.us

PERK UP THE PARK

Athletic Park

— Pavilion Fundraiser —

The new park pavilion will be a versatile asset for the whole community consisting of:

A sheltered retreat for park users.

A storage space for athletic park users.

An anonymous donor has committed to contribute substantial funds to the Town for a pavilion in the Athletic Park, matching every \$1 raised with \$3! So Please help in any way you can to perk up our park. Your donation is tax deductible.

A concession area for use during events.

To learn more and donate go to:

www.colorado.gov/ridgway/perk-park-pavilion-project



Agenda Item #9:

SURVEYOR PLANS

S1.1 SURVEY OF EXISTING CONDITIONS

S1.2 SURVEY LEGEND

LANDSCAPE AND SITE PLANS

L1.0 GENERAL NOTES
L1.1 PLANTING PLAN

L1.2 PLANTING PLAN ENLARGEMENTS


L1.3 PLANT SCHEDULE

L2.1 PLANTING DETAILS L2.2 SITE DETAILS

L2.3 ROOT BARRIER DETAIL

IRRIGATION PLANS

I1.1 IRRIGATION PLANI1.2 IRRIGATION DETAILSI1.3 IRRIGATION DETAILS

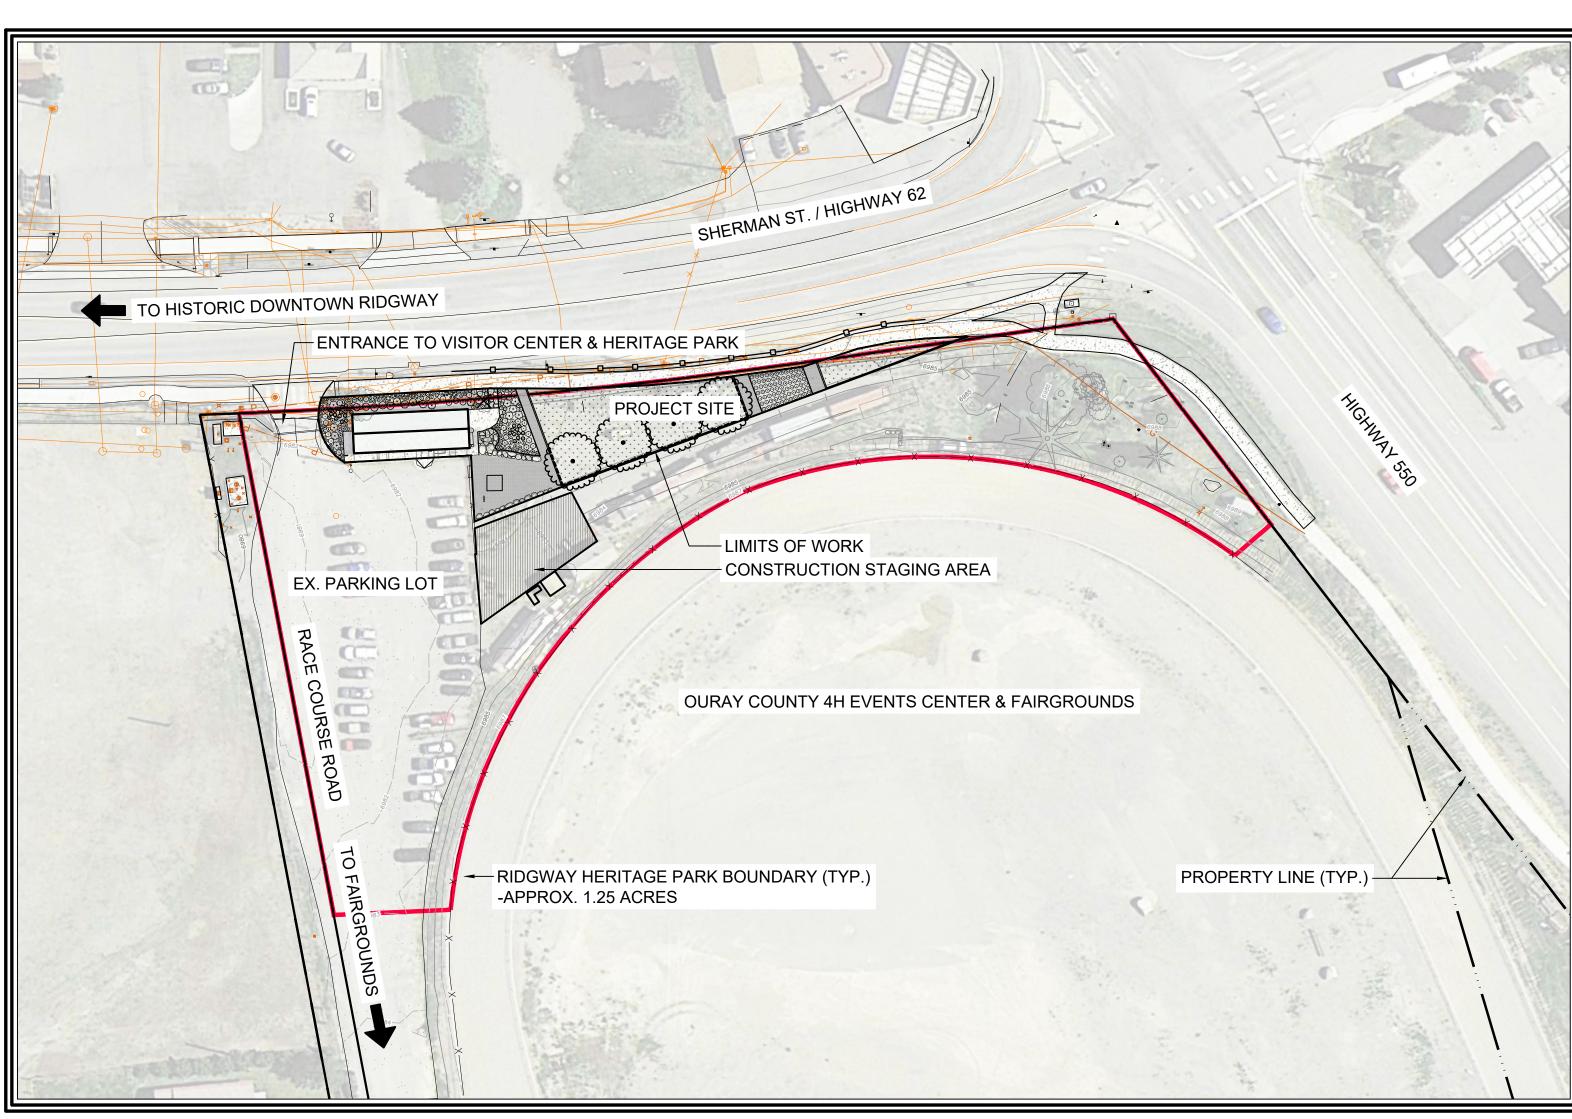

VICINITY MAP

0' 25' 50' 100 SCALE: 1" = 50'-0" PRINTED ON 24"X36" SHEET

OWNER

TOWN OF RIDGWAY, COLORADO P.O. BOX 10 RIDGWAY, CO 81432 PHONE: 970-626-5308 EXT. 215 PROJECT MANAGER CONTACT: DIEDRA SILBERT

PROJECT TEAM

LANDSCAPE ARCHITECT / PRIME DESIGN CONSULTANT

DHM DESIGN
1309 E. 3RD AVE., RM 23
DURANGO, CO 81301
PHONE: 970-385-4219
CONTACT: WALKER CHRISTENSEN

SURVEYOR

GOFF ENGINEERING & SURVEYING

126 ROCK POINT DR., STE. A

DURANGO, CO 81301

PHONE: 970-247-1705

CONTACT: BRIAN BONIFACE

IRRIGATION DESIGNER

AVOCET IRRIGATION DESIGN 7114 W. JEFFERSON AVE. LAKEWOOD, CO 80235 PHONE: 303-986-2175 CONTACT: DAVE ZICKERMAN Ridgway
Phase 1 - 90%

REVISIONS:

JOB DESCRIPTION:

90% Construction Documents


COVER

SHEET NUMBER:

SCALE: 1" = 50' - 0"

) FAIRGROUNDS



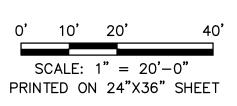



1309 East 3rd Avenue Room 23 Durango, CO 81301 970.385.4219 www.dhmdesign.com

REUSE OF DOCUMENT
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and design incorporated on this
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professional service and shall not
be used for any other project
without written authorization of
DHM Design Corp.

Ridgway Heritage Park
Phase 1 - 90% Landscape and Irrigation CDs
150 Racecourse Road, Ridgway Colorado, 81432

PROJECT NUMBER: DATE
19198.00 06/28/2019
DESIGNED: BB, SM (GOFF)
DRAWN: SM (GOFF)
CHECKED: BB (GOFF)

REVISIONS:

JOB DESCRIPTION: 90% Construction Documents

SHEET TITLE:

SURVEY OF EXISTING CONDITIONS

SCALE: 1" = 20' - 0"
SHEET NUMBER:

S1.1

SHEET 2 OF 13



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DHM Design Corp.

Ridgway Heritage Park
Phase 1 - 90% Landscape and Irrigation
150 Racecourse Road, Ridgway Colorado, 81432

JOB DESCRIPTION:
90% Construction
Documents

REVISIONS:

PROJECT NUMBER: DATE

DESIGNED: BB, SM (GOFF)

DRAWN: SM (GOFF)

CHECKED: BB (GOFF)

SHEET TITLE:

SURVEY LEGEND

SCALE: 1" = 20' - 0"
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SCALE: 1" = 20'-0"

PRINTED ON 24"X36" SHEET

S1.2

SHEET 3 OF 13

GENERAL NOTES

- 1. WORK AND MATERIALS SHALL CONFORM TO DHM DRAWINGS & SPECIFICATIONS FOR DESIGN AND CONSTRUCTION OF PUBLIC IMPROVEMENTS. ANY DIFFERENCES BETWEEN THE PROJECT'S SPECIFICATIONS AND THE TOWN STANDARDS SHALL B E COMPLETED PER THE TOWN STANDARDS.
- 2. CONTRACTOR IS RESPONSIBLE FOR ACQUIRING ANY AND ALL NECESSARY LOCAL AUTHORIZATIONS PRIOR TO WORK.
- 3. COORDINATE W/ TOWN FOR ACCESS TO SITE.
- 4. TOPOGRAPHIC SURVEY WAS SUPPLIED BY GOFF ENGINEERING.
- 5. LOCATIONS OF UTILITIES ARE GRAPHIC ONLY AND MAY NOT REPRESENT ACTUAL FIELD CONDITIONS. CONTRACTOR SHALL CALL UTILITY NOTIFICATION CENTER OF COLORADO 1-800-922-1987 TO LOCATE ALL UTILITIES PRIOR TO COMMENCING WORK. CONTRACTOR SHALL VERIFY LOCATIONS AND BURY DEPTHS OF ALL UTILITIES ON SITE. EXISTING UTILITIES SHALL BE PROTECTED FROM DAMAGE BY THE CONTRACTOR. DAMAGED UTILITIES SHALL BE REPAIRED AT THE CONTRACTORS EXPENSE.
- 6. ALL UTILITY EASEMENTS SHALL REMAIN UNOBSTRUCTED AND FULLY ACCESSIBLE ALONG THEIR ENTIRE LENGTH FOR MAINTENANCE EQUIPMENT ENTRY.
- 7. LAYOUT AND STAKING OF IMPROVEMENTS SHALL BE REVIEWED BY THE OWNER'S REPRESENTATIVE PRIOR TO INSTALLATION OF IMPROVEMENTS. NOTIFICATION OF REQUEST FOR FIELD STAKING REVIEW SHALL BE MADE A MINIMUM OF 48 HOURS IN ADVANCE
- 8. PROPOSED FINISHED SURFACES, MULCH, AND CRUSHER FINES SHALL ABUT EXISTING CURBS, PAVEMENTS, ETC., IN BOTH LINE AND GRADE. CONTRACTOR SHALL NOTIFY THE OWNER'S REPRESENTATIVE IMMEDIATELY OF ANY DISCREPANCIES.
- 9. CONTRACTOR SHALL BE RESPONSIBLE FOR REPLACING OR REPAIRING EXISTING LANDSCAPE, GRADING, SIGNAGE, IRRIGATION, HARDSCAPE, OR OTHER ITEMS THAT HAVE BEEN DAMAGED DURING CONSTRUCTION AT CONTRACTOR'S EXPENSE.
- 10. ALL QUANTITIES ARE BASED ON HORIZONTAL PLAN MEASUREMENTS AND CONSTRUCTION DETAILS. CONTRACTOR SHALL MAKE ALLOWANCES FOR SLOPE FACTOR, OVERLAP, TRENCHING, ETC.
- 11. DIGITAL DRAWINGS CAN BE PROVIDED TO THE CONTRACTOR FOR LAYOUT INFORMATION IF NEEDED.
- 12. IF THERE ARE DISCREPANCIES BETWEEN THE DRAWINGS AND THE SPECIFICATIONS, THEN THE MORE STRINGENT REQUIREMENT APPLIES.

PLANTING NOTES

- 1. PLANT CALIPER AND CONTAINER SIZE SHALL BE IN CONFORMANCE WITH TOWN OF RIDGWAY CODES AND STANDARDS.
- THE CONTRACTOR SHALL FOLLOW THE LANDSCAPE PLAN. ANY DISCREPANCIES BETWEEN THE PLAN AND FIELD CONDITIONS SHALL BE REPORTED TO THE LANDSCAPE ARCHITECT AND OWNER'S REPRESENTATIVE BEFORE PROCEEDING WITH WORK.
- 3. THE CONTRACTOR SHALL BE RESPONSIBLE FOR LOCATING ALL UTILITIES BEFORE WORK BEGINS.
- 4. IF THERE ARE CONFLICTS BETWEEN UTILITIES AND PLANTINGS, THE CONTRACTOR SHALL CONTACT THE LANDSCAPE ARCHITECT AND OWNER'S REPRESENTATIVE TO COORDINATE FIELD ADJUSTMENTS.
- 5. FIELD STAKE IRRIGATION MAINLINE AND TREE LOCATIONS FOR REVIEW BY LANDSCAPE ARCHITECT AND OWNER'S REPRESENTATIVE. TREES SHALL BE A MINIMUM OF 10'-0" FROM ALL UTILITIES, UNLESS OTHERWISE APPROVED. ALL TREES TO BE A MINIMUM OF 5'-0" FROM HARDSCAPE.
- 6. LOCATIONS OF TREES AND SHRUBS TO BE STAKED AND REVIEWED BY LANDSCAPE ARCHITECT AND OWNER'S REPRESENTATIVE PRIOR TO PLANTING.
- 7. NOTIFY LANDSCAPE ARCHITECT AND OWNER'S REPRESENTATIVE FOR INSPECTION AND/OR APPROVAL OF LANDSCAPE MATERIALS AND IRRIGATION PRODUCTS PRIOR TO INSTALLATION.
- 8. CONTRACTOR TO NOTIFY LANDSCAPE ARCHITECT AND OWNER'S REPRESENTATIVE 48 HOURS PRIOR TO PLANT MATERIAL BEING DELIVERED TO THE SITE.
- 9. FIELD ADJUST PLANTINGS FOR TRANSFORMERS, CURB CUTS, AND OTHER FUTURE IMPROVEMENTS. STAKE LOCATIONS FOR APPROVAL BY LANDSCAPE ARCHITECT AND OWNER'S REPRESENTATIVE PRIOR TO ANY INSTALLATION.
- 10. IF THERE IS A DISCREPANCY BETWEEN THE PLANT COUNTS ON THE CALL-OUTS ON THE PLANS & THE ACTUAL NUMBER OF PLANTS DEPICTED ON THE PLANS, THE CONTRACTOR IS RESPONSIBLE FOR INSTALLING THE ACTUAL NUMBER OF PLANTS AS DEPICTED ON THE PLANS.
- 11. ALL AREAS DISTURBED OUTSIDE THE ORIGINAL PLANTING LIMITS OF WORK, SHOWN ON DRAWING TO BE RE-SEEDED, RE-GRADED, AND REPAIRED AS APPROPRIATE AT CONTRACTOR'S EXPENSE.
- 12. ALL BED AREAS WILL RECEIVE A MINIMUM OF 4" OF CEDAR BARK MULCH OR APPROVED EQUAL. ALL TREES WILL RECEIVE 4" CEDAR BARK MULCH WITHIN THE SAUCER AREA PER THE DETAILS. THE CONTRACTOR IS RESPONSIBLE FOR WEED CONTROL ON BEDS AND SODDED AREAS UNTIL FINAL PROJECT ACCEPTANCE. USE CEDAR BARK MULCH, TYP.
- 13. ALL SOD AND SHRUB BEDS TO BE CONTAINED BY STEEL EDGER OR CONCRETE EDGE (&/OR A CONCRETE CURB OR WALK, AS PER PLANS).
- 14. THE CONTRACTOR SHALL WARRANTY ALL PLANT MATERIALS, WORKMANSHIP, & IRRIGATION SYSTEM FOR A PERIOD OF ONE YEAR. ALL WARRANTY ITEMS SHALL BE PER TOWN OF RIDGWAY STANDARDS.
- 15. ALL TREES TO HAVE WILDLIFE FENCING PER DETAIL 6/L2.1. WILDLIFE PROTECTION FENCING INSTALLED TO PROTECT TREES SHALL BE MAINTAINED THROUGHOUT THE WARRANTY PERIOD. PLACEMENT OF WILDLIFE FENCING DOES NOT RELIEVE THE CONTRACTOR OF RESPONSIBILITY FOR ANY DAMAGE TO TREES DURING THE WARRANTY PERIOD.
- 16. CONTRACTOR SHALL BE RESPONSIBLE FOR PROTECTION AND REPLACEMENT OF ANY AND ALL DAMAGE TO EXISTING LANDSCAPE AND IRRIGATION WITHIN PROJECT SITE AND ADJACENT TO THE PROJECT.
- 17. ALL TURF SOD AND SHRUB AREAS WILL HAVE 6" MIN. DEPTH OF TOPSOIL INSTALLED. THESE AREAS WILL THEN BE TILLED TO A MINIMUM 8" DEPTH INCORPORATING A-1 ORGANICS BIOCOMP CLASS 1 COMPOST (OR APPROVED EQUAL) AT A MINIMUM RATE OF 4 C.Y. PER 1000 S.F IN TURF SOD AREAS AND SHRUB BEDS. (INSTALL 12" DEPTH OF TOPSOIL TO BE PLACED IN THE AREAS WHERE CONCRETE AND RUBBLE HAVE BEEN REMOVED.) THE DISTURBED AREAS OF THE SITE WILL THEN BE FINE GRADED IN PREPARATION FOR SODDING OR PLANTING AS SPECIFIED IN THE PLANS AND SPECIFICATIONS. SOIL PREPARATION AND AMENDMENTS WILL NOT BE MEASURED SEPARATELY BUT WILL BE INCLUDED IN THE COST OF THE PLANTS.
- 21. THE CONTRACTOR SHALL MAINTAIN POSITIVE DRAINAGE AWAY FROM ALL STRUCTURES AND WALKWAYS. FINE GRADING MUST BE APPROVED BY OWNER'S REPRESENTATIVE PRIOR TO SEEDING AND PLANTING.
- 22. IF THERE IS A DISCREPANCY BETWEEN THE SPECIFICATIONS AND THE DRAWINGS, THE MORE STRINGENT CONDITION APPLIES.



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ay Heritage Park 90% Landscape and Irrigation C se Road, Ridgway Colorado, 81432

PROJECT NUMBER: DATE
19198.00 06/28/20

Rid Phase

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DESIGNED: WC, CW
DRAWN: CW
CHECKED: WC

REVISIONS:


JOB DESCRIPTION:
90% Construction
Documents


SHEET TITLE:

GENERAL NOTES

SCALE: SHEET NUMBER:

L1.0

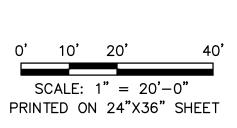

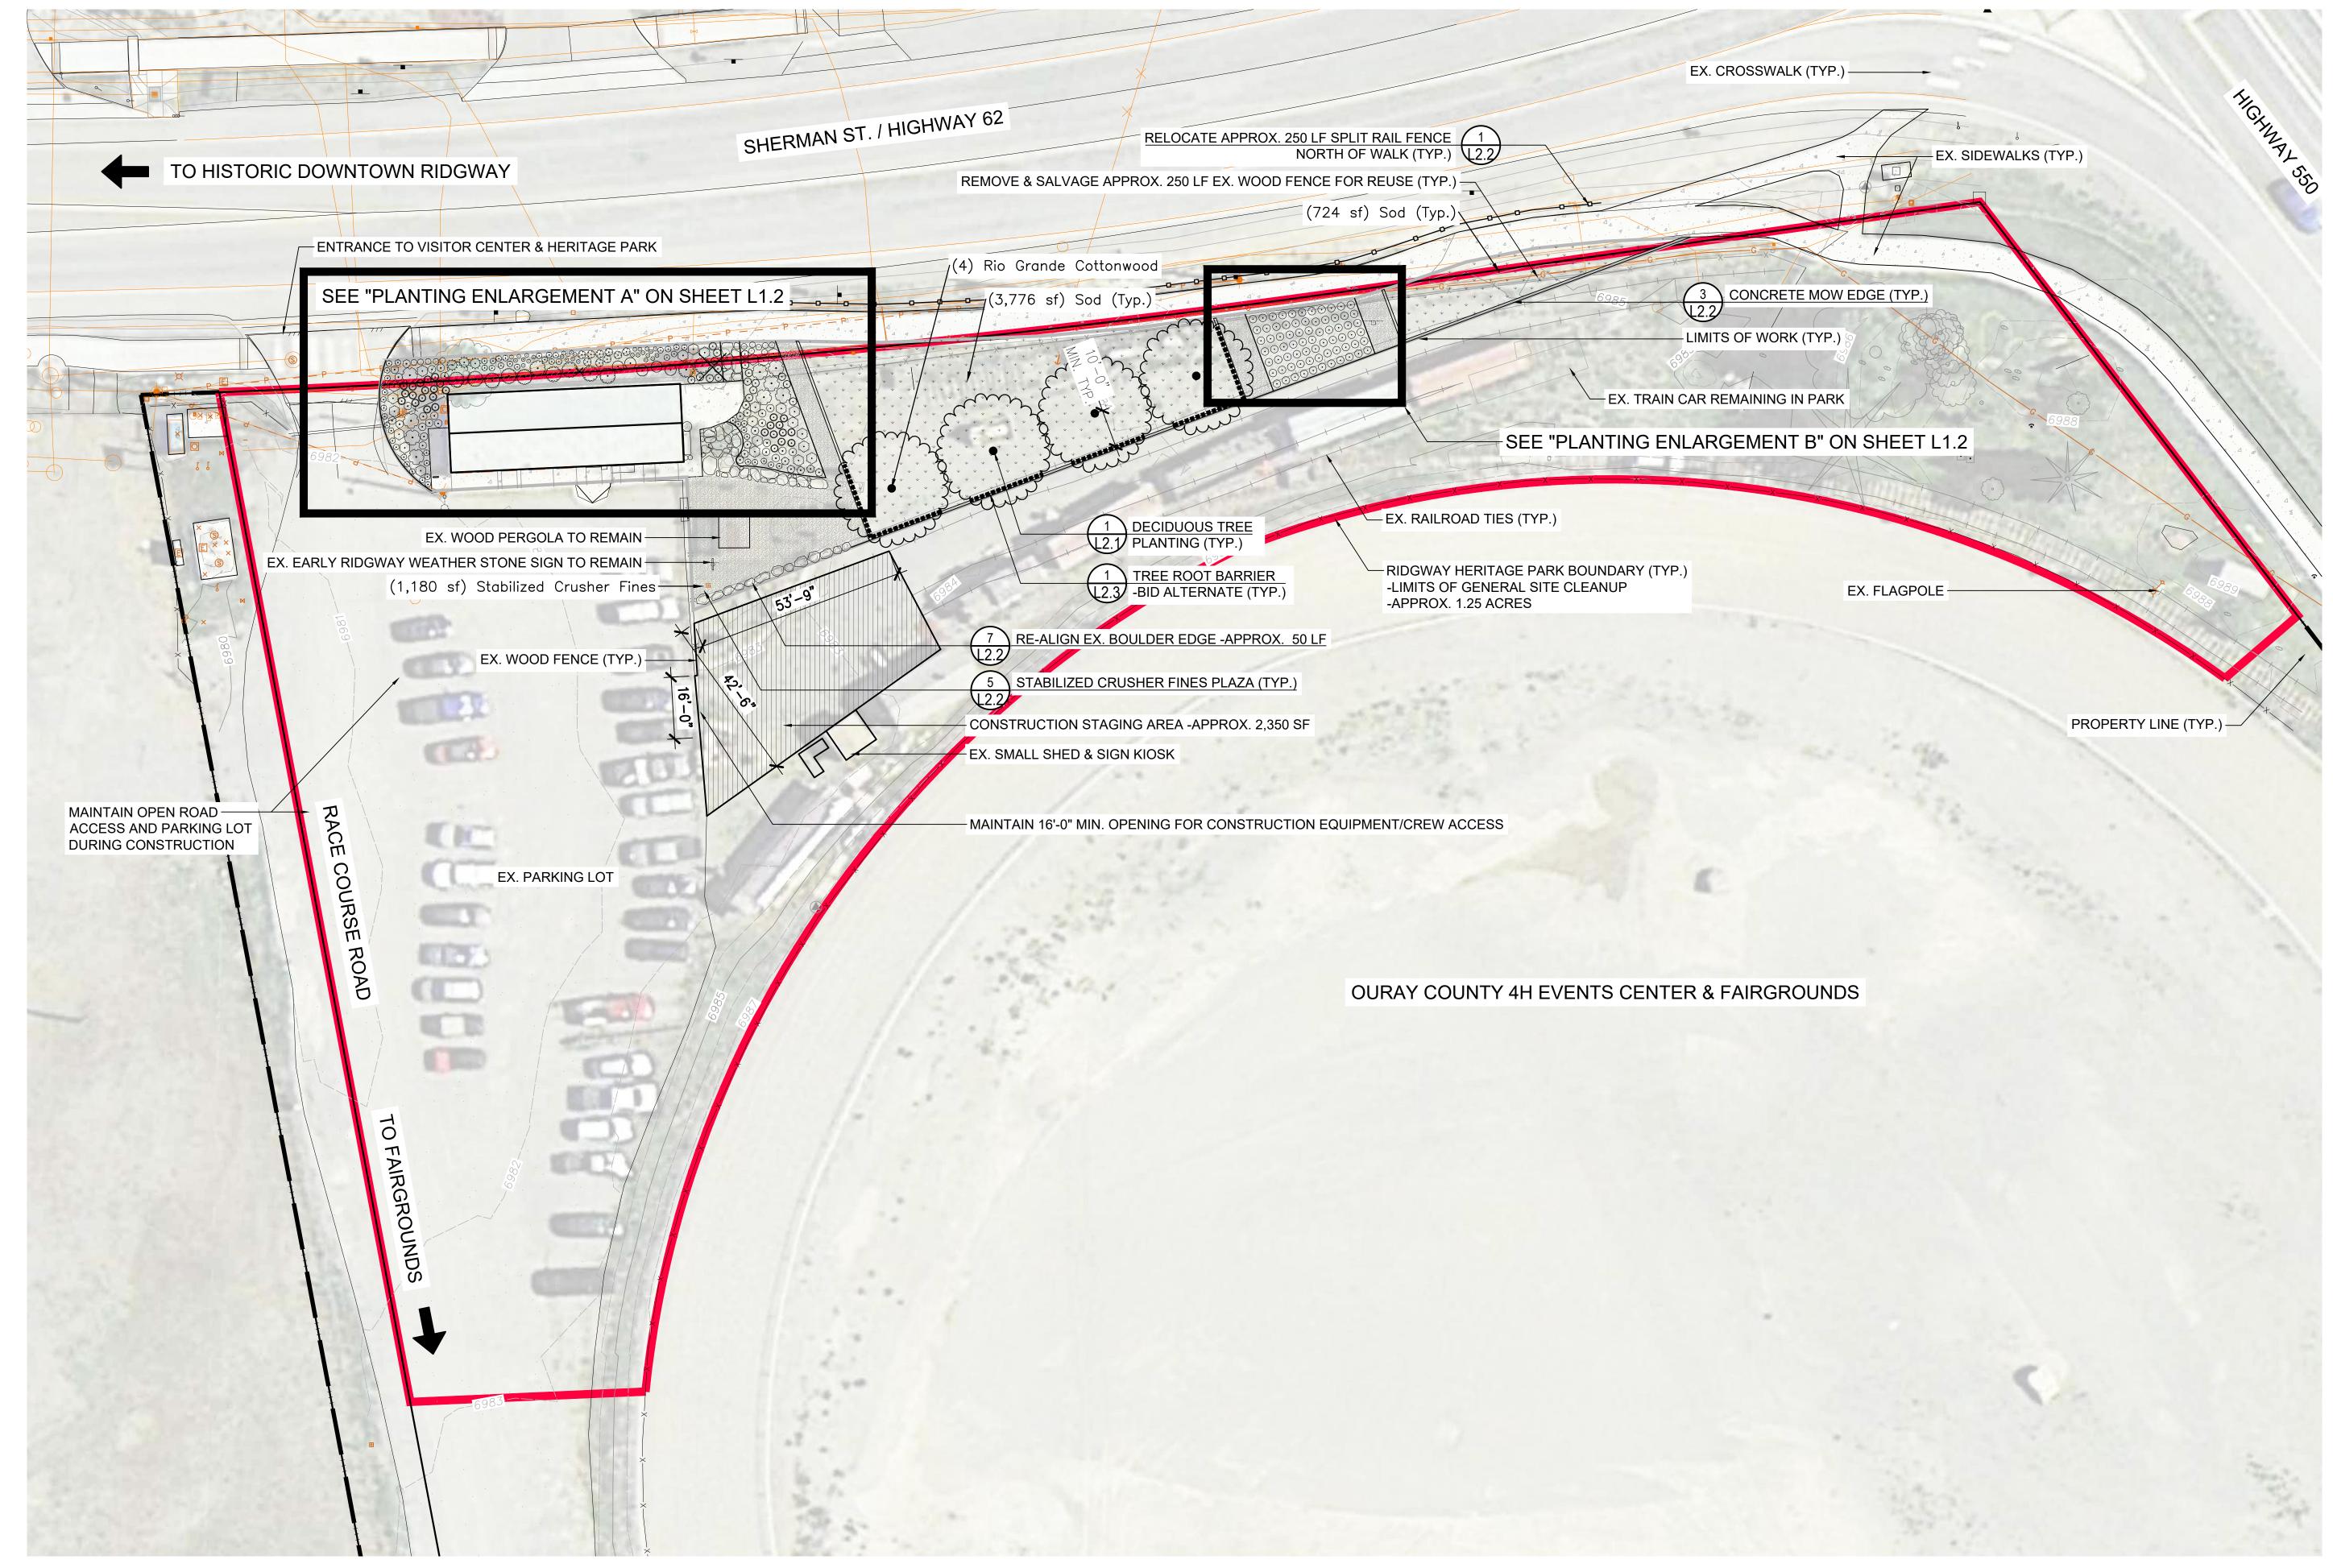

NOTES:

1. CONTRACTOR TO REMOVE CONSTRUCTION EQUIPMENT, MATERIALS, AND DEBRIS FROM SITE UPON COMPLETION OF PROJECT.

2. CONTRACTOR TO PROVIDE WEEDING, DEBRIS REMOVAL, AND GENERAL CLEAN UP FOR ENTIRE HERITAGE PARK SITE -SEE RED PARK SITE BOUNDARY LINE FOR LIMITS OF CLEANUP.

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Irrigation o, 81432 ark p an Heritage andscape Ridgway Phase

PROJECT NUMBER: 19198.00 **DATE** 06/28/2019 DESIGNED: WC, CW
DRAWN: CW
CHECKED: WC

REVISIONS:

JOB DESCRIPTION: 90% Construction


Documents SHEET TITLE:

PLANTING PLAN


SCALE: 1'' = 20' - 0''SHEET NUMBER:

SHEET 5 OF 13


PLANTING ENLARGEMENT A

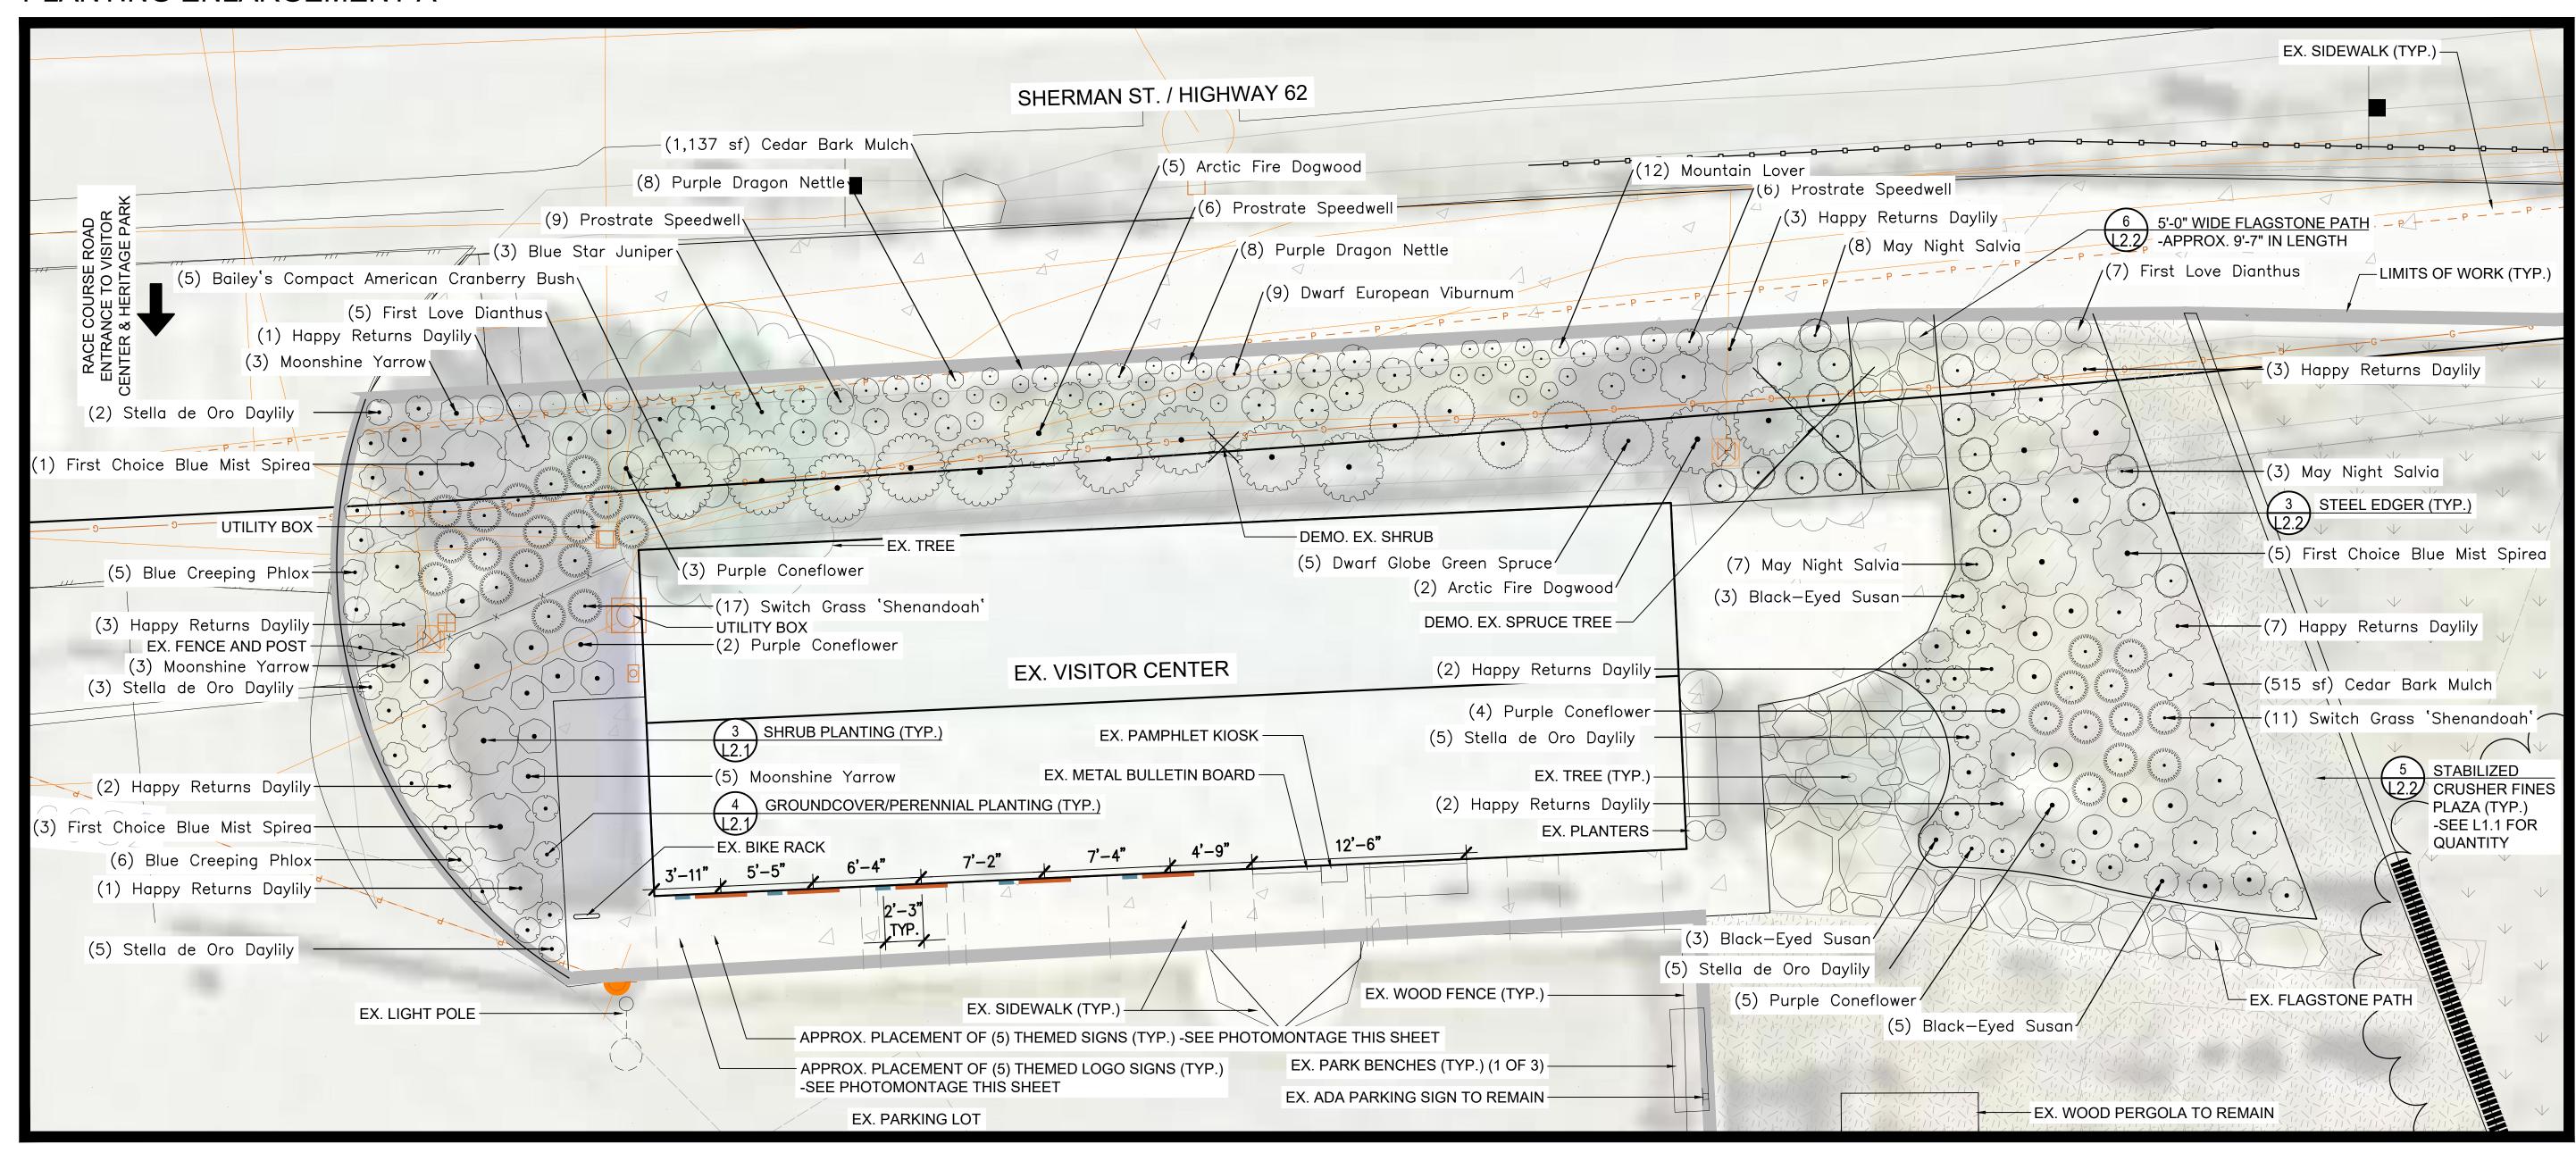

PLANTING ENLARGEMENT B

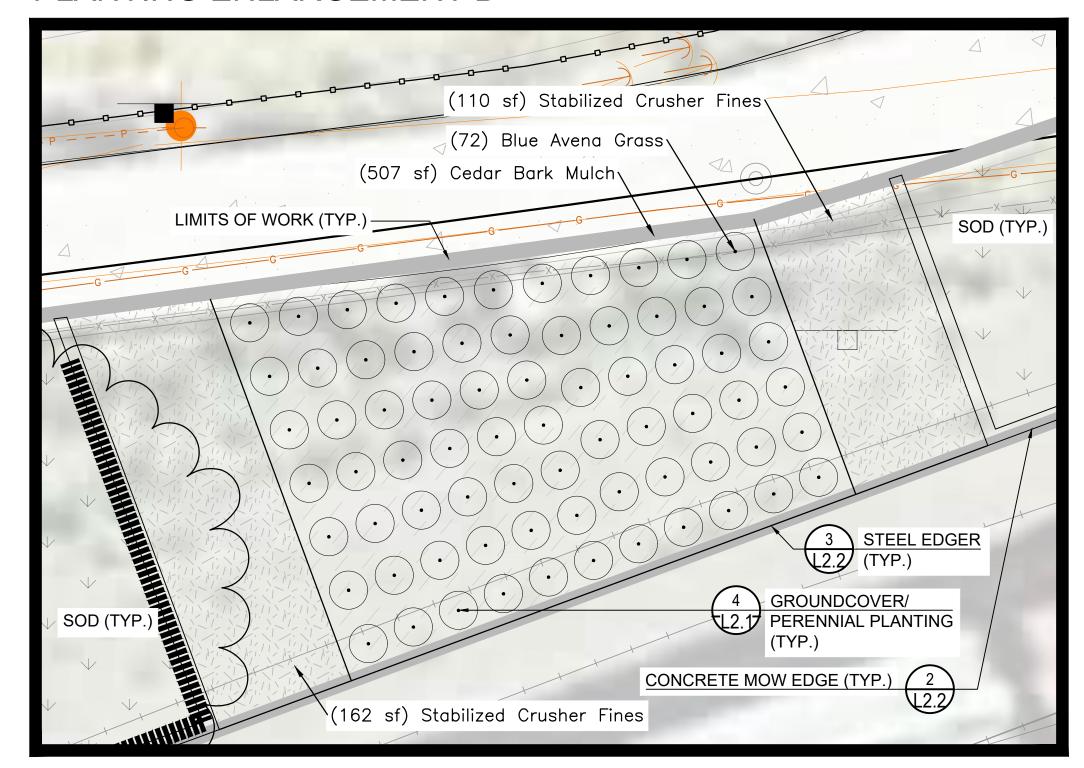



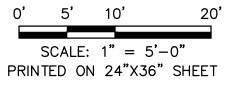



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Ridgway Heritage Park
Phase 1 - 90% Landscape and Irrigation CE
150 Racecourse Road, Ridgway Colorado, 81432

DESIGNED: WC, CW
DRAWN: CW
CHECKED: WC
REVISIONS:

PROJECT NUMBER: 19198.00

JOB DESCRIPTION:
90% Construction

Documents

SHEET TITLE:

PLANTING PLAN ENLARGEMENTS

SCALE: 1" = 10' - 0"
SHEET NUMBER:

L12

SHEET 6 OF 13

SOD/TURF: SOD TO BE HYBRID FIVE WAY THERMAL BLUE BLUEGRASS BLEND SUPPLIED BY SUPERIOR SOD, LLC OR APPROVED EQUAL. SOD SHALL BE ADAPTED TO THE AREA, DROUGHT TOLERANT, AND MEANT FOR HIGH ALTITUDE CLIMATES. PHONE: 970-252-1763 ADDRESS: 57518 IDA RD., MONTROSE, CO 81403

PLANT SCHEDULE

TREES	COMMON / BOTANICAL NAME	<u>CONT</u>	QTY
£ • 3	RIO GRANDE COTTONWOOD / POPULUS DELTOIDES WISLIZENII	10 GAL	4
SHRUBS	COMMON / BOTANICAL NAME	CONT	QTY
	FIRST CHOICE BLUE MIST SPIREA / CARYOPTERIS X CLANDONENSIS 'FIRST CHOICE'	5 GAL	9
	ARCTIC FIRE DOGWOOD / CORNUS SERICEA 'ARCTIC FIRE'	5 GAL	7
•	BLUE STAR JUNIPER / JUNIPERUS SQUAMATA 'BLUE STAR'	5 GAL	3
•	DWARF GLOBE GREEN SPRUCE / PICEA PUNGENS 'ROUNDABOUT'	5 GAL	5
	DWARF EUROPEAN VIBURNUM / VIBURNUM OPULUS 'NANUM'	5 GAL	9
£ • 33	BAILEY'S COMPACT AMERICAN CRANBERRY BUSH / VIBURNUM TRILOBUM 'BAILEY COMPACT'	5 GAL	5
ORNAMENTAL GRASSES	COMMON / BOTANICAL NAME	<u>CONT</u>	<u>QTY</u>
•	BLUE AVENA GRASS / HELICTOTRICHON SEMPERVIRENS	1 GAL	72
O DANAMARIA	SWITCH GRASS 'SHENANDOAH' / PANICUM VIRGATUM	1 GAL	28
<u>PERENNIALS</u>	COMMON / BOTANICAL NAME	CONT	QTY
•	MOONSHINE YARROW / ACHILLEA MILLEFOLIUM 'MOONSHINE'	1 GAL	11
	FIRST LOVE DIANTHUS / DIANTHUS X 'FIRST LOVE'	1 GAL	12
•	PURPLE CONEFLOWER / ECHINACEA PURPUREA	1 GAL	14
	HAPPY RETURNS DAYLILY / HEMEROCALLIS X 'HAPPY RETURNS'	1 GAL	24
	STELLA DE ORO DAYLILY / HEMEROCALLIS X 'STELLA DE ORO'	1 GAL	20
	PURPLE DRAGON NETTLE / LAMIUM MACULATUM 'PURPLE DRAGON'	1 GAL	16
•	MOUNTAIN LOVER / PAXISTIMA CANBYI	1 GAL	12
•	BLUE CREEPING PHLOX / PHLOX SUBULATA 'BLUE'	1 GAL	11
	BLACK-EYED SUSAN / RUDBECKIA FULGIDA 'GOLDSTRUM'	1 GAL	11
	MAY NIGHT SALVIA / SALVIA X SYLVESTRIS 'MAY NIGHT'	1 GAL	18
	PROSTRATE SPEEDWELL / VERONICA PROSTRATA	1 GAL	21
GROUND COVERS	COMMON / BOTANICAL NAME	CONT	QTY
	CEDAR BARK MULCH	MULCH	2,159 SF
	SOD (TYP.)	SOD	4,500 SF
	STABILIZED CRUSHER FINES	CRUSHER FINES	1,452 SF

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Park
nd Irrigation (ado, 81432 Ridgway Heritage F Phase 1 - 90% Landscape and 150 Racecourse Road, Ridgway Colorado

PROJECT NUMBER: DATE 19198.00 06/28/2019 DESIGNED: WC, CW
DRAWN: CW
CHECKED: WC

REVISIONS:

JOB DESCRIPTION: 90% Construction Documents

SHEET TITLE:

PLANT SCHEDULE

SHEET NUMBER:

5. ADD FERTILIZER TABLETS PER MANUFACTURER'S 6. STAKE ALL TREES.

IMMEDIATELY AFTER PLANTING.

RECOMMENDATION.


DECIDUOUS TREE PLANTING DETAIL L2.1

WIND WIND


SEE 2/L2.1 FOR TREE WATERING SCHEDULE.


TREE WATERING NEEDS SMALL TREES **MEDIUM TREES** LARGE TREES APRIL THRU OCTOBER WEEKLY 3x PER MONTH 2x PER MONTH 10 GAL/INCH 10 GAL/INCH 15 GAL/INCH 4" 6" 8" 10" 12" 14" TREE TRUNK DIAMETER 1" 2" 3" 5 10 15 20 30 40 75 90 105 **DEEP ROOT FORK** MINUTES MINUTES **MINUTES** 2 GAL/MIN 5 10 15 20 30 40 75 90 105 **DEEP ROOT NEEDLE** MINUTES **MINUTES** MINUTES 2 GAL/MIN 3 5 8 10 15 20 38 45 53 **SOFT SPRAY WAND** MINUTES MINUTES MINUTES 4 GAL/MIN 5 10 15 20 30 40 75 90 105 **SOAKER HOSE** MINUTES MINUTES **MINUTES** 2 GAL/MIN


TREE WATER SCHEDULE DETAIL - DECIDUOUS TREES L2.1 NOT TO SCALE

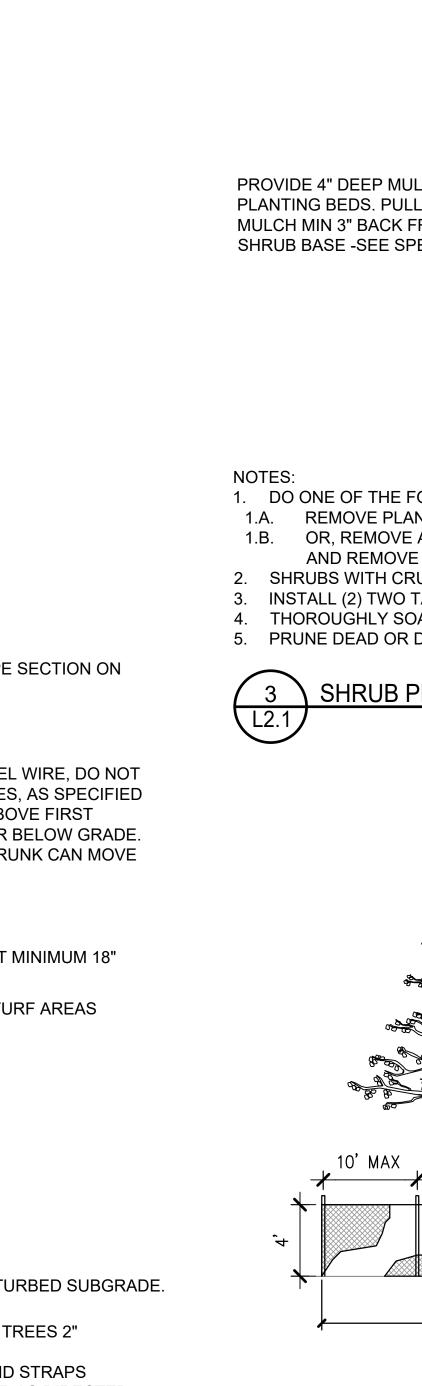

NOT TO SCALE

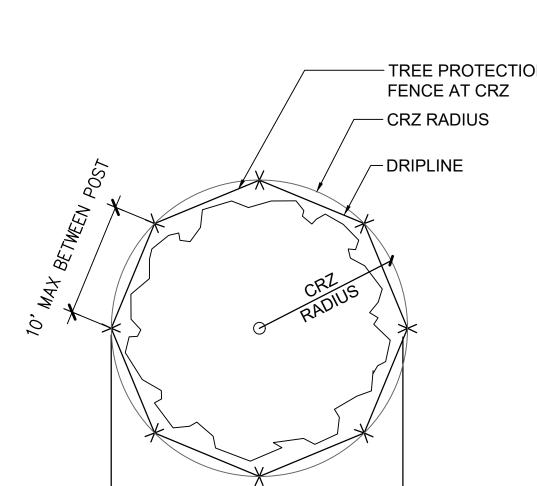

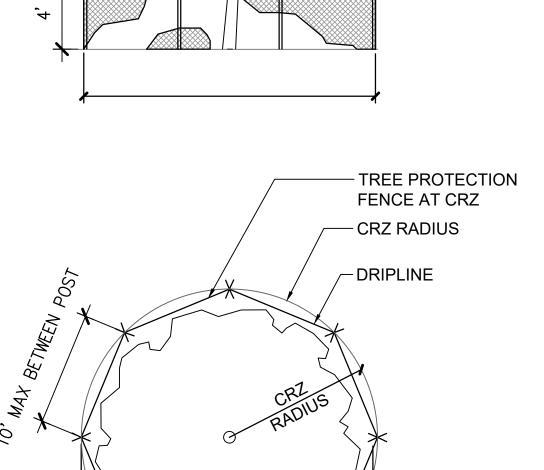

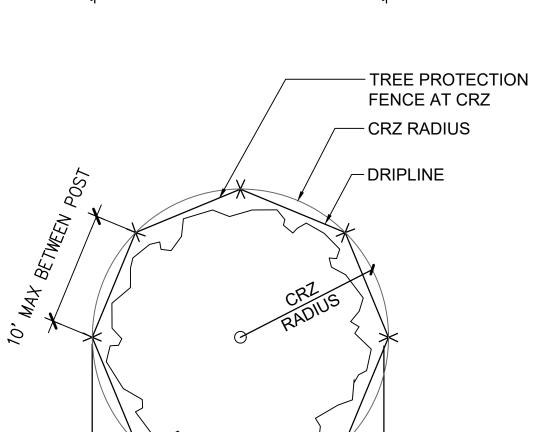

TREE PROTECTION FENCING

L2.1

PLACE CROWN OF ROOTBALL 2" ABOVE FINISH GRADE PREPARED BACKFILL (1/3) COMPOST & \frac{2}{3} EXCAVATED PROVIDE 4" DEEP MULCH IN - 4" HIGH SAUCER TO HOLD MULCH MULCH MIN 3" BACK FROM -FINISH GRADE SHRUB BASE -SEE SPECS. EXISTING SUBSOIL SCARIFY BOTTOM OF HOLE SCORE ROOTBALL & TEASE ROOTS **OUTWARD TO ENCOURAGE** PENETRATION INTO BACKFILL

DO ONE OF THE FOLLOWING

10' MAX

1.A. REMOVE PLANT FROM POT AND PROTECT ROOTBALL FROM DAMAGE DURING PLANTING.

TREE PROTECTION FENCE

OR, REMOVE ALL WIRE, TWINE, AND PLASTIC FROM ROOTBALL. AFTER PLANT IS SET, PULL BACK AND REMOVE BURLAP FROM TOP 1/2 OF ROOTBALL. SLIT REMAINING BURLAP.

2. SHRUBS WITH CRUMBLED OR BROKEN ROOTBALLS WILL BE REJECTED. INSTALL (2) TWO TABLETS PER SHRUB

SHRUB PLANTING DETAIL

THOROUGHLY SOAK PLANTING HOLE WHILE BACKFILLING.

PRUNE DEAD OR DAMAGED BRANCHES IMMEDIATELY AFTER PLANTING.

NOT TO SCALE

TREE PROTECTION NOTES

THE CRITICAL ROOT ZONE OF A TREE IS THE ZONE IN WHICH THE MAJORITY OF A TREE'S ROOTS LAY. NINETY-FIVE PERCENT OF THE ROOTS OF MOST TREES WILL BE FOUND IN THE UPPER 30-36" OF THE SOIL. OF THOSE THE MAJORITY OF THE ROOTS THAT SUPPLY THE NUTRIENTS AND WATER TO THE TREE ARE FOUND IN THE UPPERMOST LAYER, JUST BELOW THE SOIL SURFACE. THE TOTAL AMOUNT OF A TREE'S ROOTS ARE GENERALLY PROPORTIONAL TO VOLUME OF THE TREE CANOPY. THEREFORE IF THE ROOTS ONLY PENETRATE A THIN LAYER OF SOIL THEN THE ROOTS MUST SPREAD FAR FROM THE TREE BEYOND THE LIMITS OF THE CANOPY. ROOTS ARE VITAL TO THE FUNCTION OF ANY TREE.

THE RADIUS OF THE CRITICAL ROOT ZONE IS TO BE CALCULATED BY PROVIDING 1.5' OF RADIUS FOR EVERY 1" OF DBH. THE DBH IS THE CALIPER DIAMETER OF THE TREE AT 4' FROM THE GROUND.

CONSTRUCTION ACTIVITIES ARE TO BE AVOIDED IN THE CRITICAL ROOT ZONE. CONSTRUCTION ACTIVITIES THAT ARE REQUIRED WITHIN THIS ZONE ARE TO BE DONE WITH HAND EQUIPMENT AND NO ROOT GREATER THAN 2" IN DIAMETER IS TO BE CUT PRIOR TO APPROVAL OF THE CITY ARBORIST.

ALL TRENCHING REQUIRED WITHIN THE ROOT ZONE IS TO BE DONE BY AIR SPADE.

FENCE IS TO BE MAINTAINED BY CONTRACTOR THROUGHOUT THE EXTENT OF CONSTRUCTION.

NO HEAVY EQUIPMENT IS TO BE STORED OR STAGED WITHIN THE CRITICAL ROOT ZONE.

NO CHEMICAL STORAGE, WASHING OF PAINT OR OTHER CHEMICALS IS ALLOWED WITHIN THE CRITICAL ROOT ZONE.

NOT TO SCALE

FINISH GRADE 4" CEDAR BARK MULCH TILL IN COMPOST 25% IN PLANTING BED

GROUNDCOVER/PERENNIAL PLANTING DETAIL NOT TO SCALE

✓ SET TREE FASTENERS ABOVE WELDED WIRE FENCE - 48" TALL 1"X2" 14 GAUGE GALVANIZED WELDED WIRE

WILDLIFE FENCING 10:1 AND LESS SLOPE

NOTES:

1. FOR EVERGREEN TREES, WRAP FENCING AT DRIP LINE OF

WRAP FENCING AROUND TREE TWO TIMES FOR FUTURE ADJUSTMENT CAPABILITY. SECURE WITH WIRE.

L2.1 NOTES:

WILDLIFE PROTECTION FENCING

NOT TO SCALE WILDLIFE PROTECTION FENCING NOT SHOWN ON PLANS. CONTRACTOR TO INSTALL PER DETAIL.

leritage aRidgwa Phase 1 - (

> PROJECT NUMBER: DATE 19198.00 06/28/2019 DESIGNED: WC, CW DRAWN: CW CHECKED: WC

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REVISIONS:

JOB DESCRIPTION: 90% Construction Documents

SHEET TITLE:


PLANTING DETAILS

SCALE: AS SHOWN SHEET NUMBER:

SHEET<u>8</u> OF 13

NOTE: IMAGE SHOWN FOR REFERENCE ONLY. MATCH EXISTING FENCE.




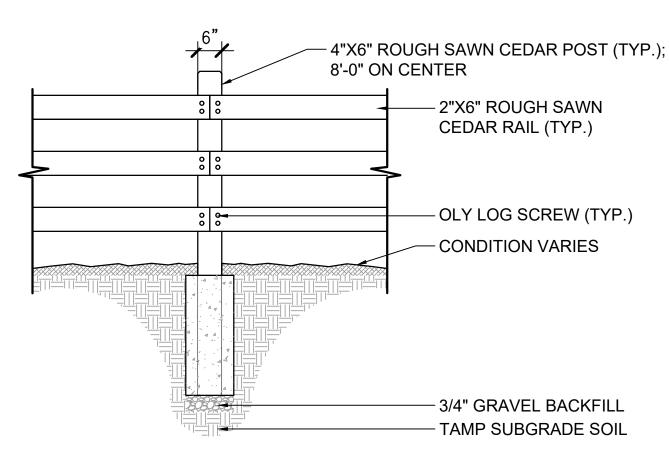


NOTES: 1. USE #1 GRADE CEDAR WOOD TREATED/STAINED TO A NATURAL CEDAR APPEARANCE. DETAIL SHOWN FOR REFERENCE. MATCH EXISTING FENCE NUMBER OF RAILS, MATERIALS, STYLE, AND FINISH.

2. SIDE OF FENCE SHOWN IN THIS DETAIL TO FACE THE ANIMAS RIVER TRAIL.

SPLIT RAIL FENCE

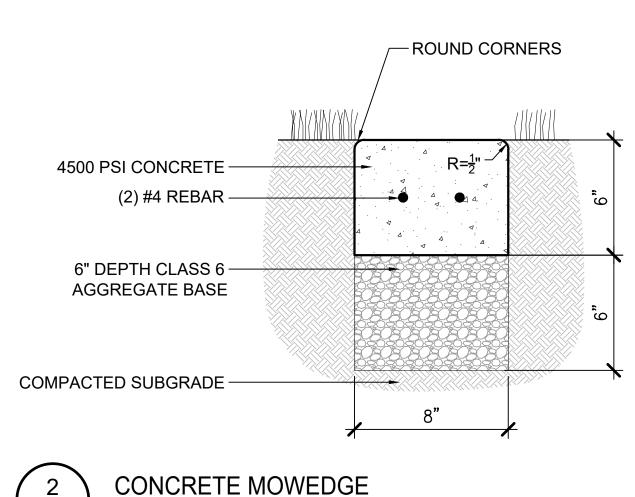

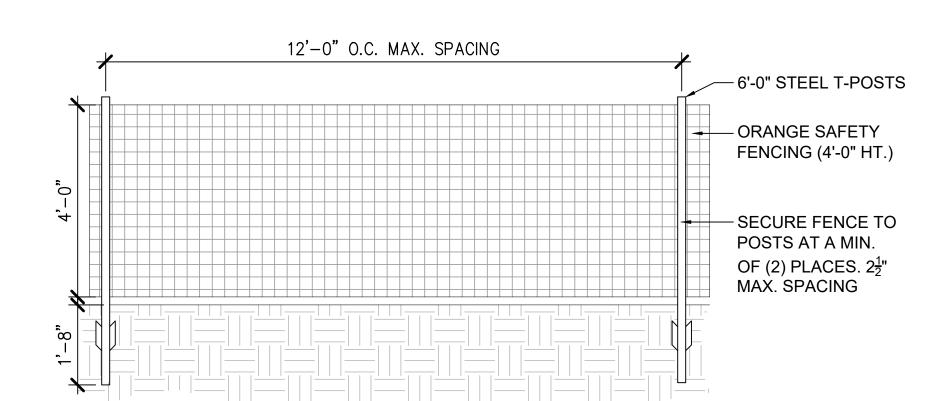


NOT TO SCALE

ORANGE PLASTIC CONSTRUCTION FENCING

- SHRUB BED W/ SPECIFIED MULCH DEPTH — KID/PET FRIENDLY STEEL EDGER; EDGER TO HAVE BENT TOP TO PREVENT CUTTING LAWN AS SPECIFIED - 4" STEEL EDGING LANDSCAPE FABRIC -ROLL EDGE UNDER STEEL EDGING AS SHOWN - METAL STAKES

- 1. SET ALL EDGING 1" ABOVE FINISHED GRADE AS SHOWN. 2. EDGING SHALL ABUT ALL CONCRETE CURBS AND WALKS
- PERPENDICULAR, AND FLUSH W/ GRADES OF CONCRETE.
- 3. ALL JOINTS TO BE SECURELY STAKED.
- 4. CONTRACTOR SHALL CUT TOP EDGE(S) AS NEEDED TO
- BE PARALLEL WITH GRADE.

STEEL EDGER NOT TO SCALE

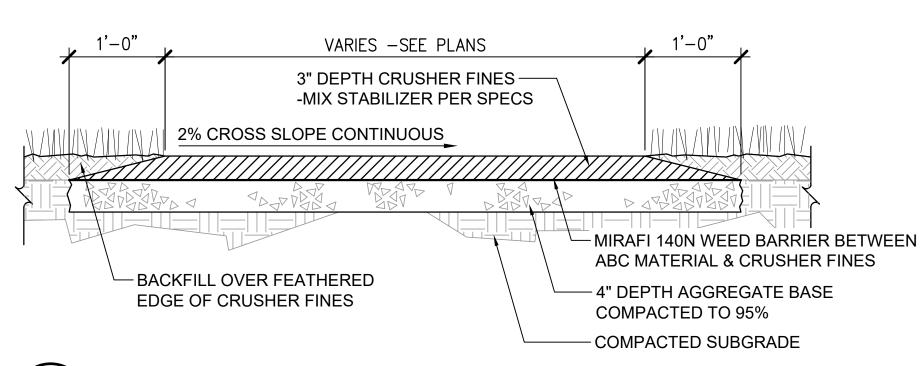

STABILIZED CRUSHER FINES

NOTE: CRUSHER FINES PLAZA TO HAVE 1.9% SLOPE MAX. IN ALL DIRECTIONS. IF SLOPE EXCEEDS 1.9%, NOTIFY OWNER'S REPRESENTATIVE IMMEDIATELY FOR FIELD ADJUSTMENT.


NOT TO SCALE

FLAGSTONE PATH

NOTE: IMAGE SHOWN FOR REFERENCE ONLY. MATCH EXISTING FLAGSTONE PATH.

NOT TO SCALE

L2.2

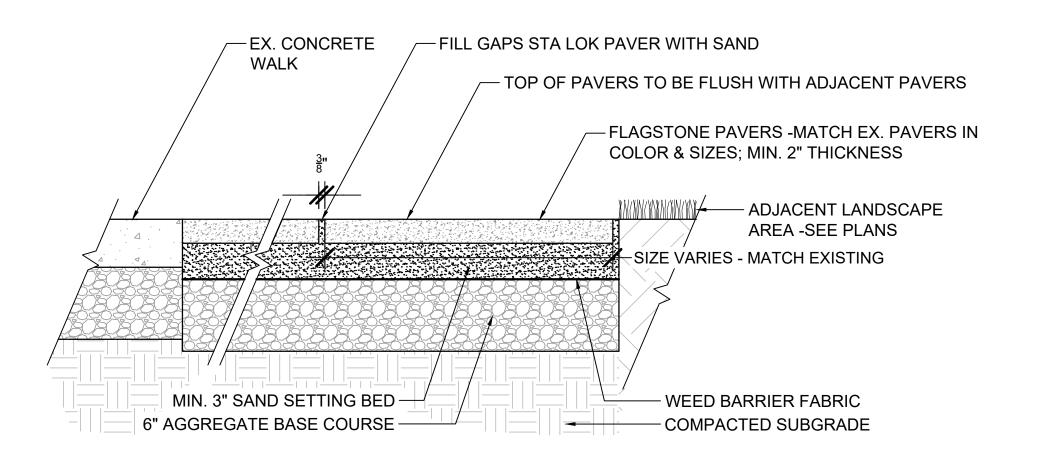


NOT TO SCALE

L2.2 NOTES: MATCH EXISTING FLAGSTONE PATH COLOR AND SIZES.

MAX. GAP BETWEEN PAVERS SHOULD BE $\frac{3}{8}$ " TO PROVIDE FOR ADA ACCESS.



NOTE: IMAGE SHOWN FOR REFERENCE ONLY. MATCH EXISTING BOULDER EDGE.

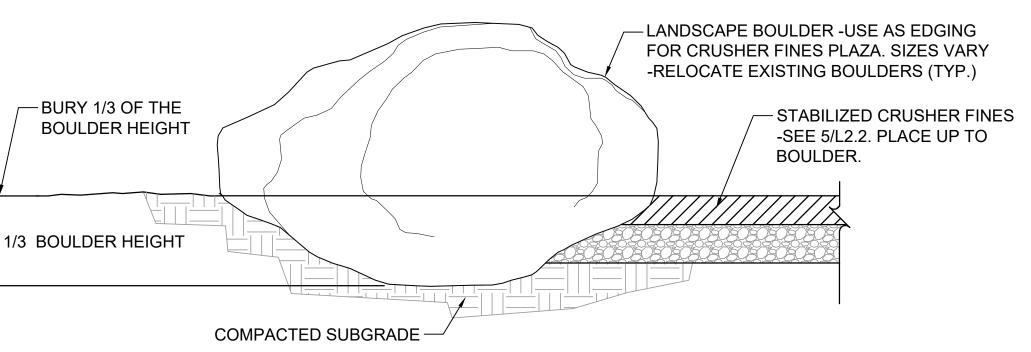


NOT TO SCALE

BOULDER EDGE

SHOWN ABUTTING STABILIZED CRUSHER FINES

RELOCATE EXISTING BOULDERS TO CREATE NEW EDGING ALIGNMENT.

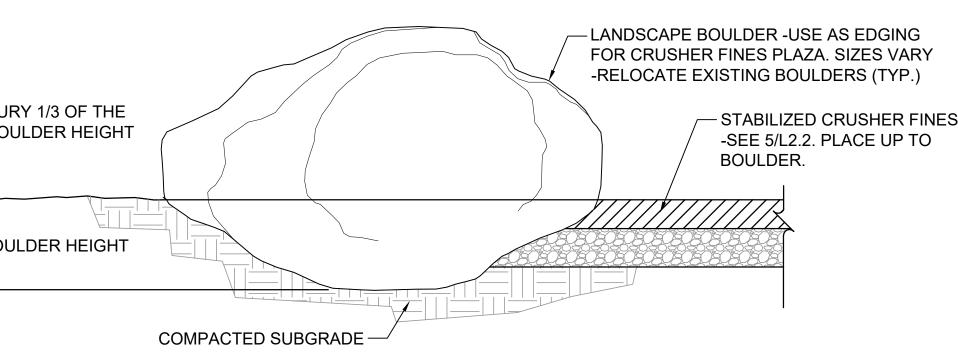

NOT TO SCALE

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Phase 1 - 90%
150 Racecourse Ro

PROJECT NUMBER: DATE 19198.00 06/28/201 DESIGNED: WC, CW DRAWN: CW CHECKED: WC **REVISIONS:**

06/28/2019

JOB DESCRIPTION: 90% Construction Documents

SHEET TITLE: SITE DETAILS

SCALE: AS SHOWN SHEET NUMBER:

SHEET 9 OF 13

SPECIFIED TREE ROOT BARRIERS ARE A MECHANICAL BARRIER AND ROOT DEFLECTOR TO PREVENT TREE ROOTS FROM DAMAGING HARDSCAPES AND LANDSCAPES. ASSEMBLED IN 2' LONG MODULES TO CREATE VARYING CYLINDERS FOR SURROUNDING ROOT BALLS (SURROUND PLANTING STYLE) OR FOR LINEAR APPLICATIONS DIRECTLY BESIDE A HARDSCAPE ADJACENT TO ONE SIDE OF THE TREES (LINEAR PLANTING STYLE)

A. MATERIALS

1. THE CONTRACTOR SHALL FURNISH AND INSTALL ROOT BARRIERS AS SPECIFIED. THE TREE ROOT BARRIERS SHALL BE PRODUCT #UB 18-2 AS MANUFACTURED BY DEEP ROOT PARTNERS, L.P., 81 LANGTON ST. #4 SAN FRANSISCO, CA (800-458-7668), OR APPROVED EQUAL. THE BARRIER SHALL BE BLACK, INJECTION MOLDED PANELS, OF .080" (2.03MM) WALL THICKNESS IN MODULES 24" (61CM) LONG BY 18" (46CM) DEEP; MANUFACTURED WITH A MINIMUM 50% POST CONSUMER RECYCLED POLYPROPYLENE PLASTIC WITH ADDED ULTRAVIOLET INHIBITORS; RECYCLABLE.

EACH PANEL SHALL HAVE: -NOT LESS THAN 4 MOLDED INTEGRAL VERTICAL ROOT DEFLECTING RIBS OF AT LEAST 0.06" (1.52MM) THICKNESS PROTRUDING $\frac{1}{2}$ " (12.7MM) AT 90° FROM INTERIOR OF THE BARRIER PANEL, SPACED 6" (15.24MM) APART (SEE PANEL DRAWING ON 18 INCH DEEPROOT TREE ROOT BARRIERS, DETAILS)

-A DOUBLE TOP EDGE CONSISTING OF TWO PARALLEL, INTEGRAL, HORIZONTAL RIBS AT THE TOP OF THE PANEL OF A MINIMUM 0.06" (6.35MM) APART WITH THE LOWER RIB ATTACHED TO THE VERTICAL ROOT DEFLECTING RIBS (SEE DETAIL "A") -A MINIMUM OF 9 ANTI-LIFT GROUND LOCK TABS CONSISTING OF INTEGRAL HORIZONTAL RIDGES OF A MINIMUM 0.06" (1.52MM) THICKNESS IN THE SHAPE OF A SEGMENT OF A CIRCLE, THE $2\frac{1}{4}$ " (57MM) CHORD OF THE SEGMENT JOINING THE PANEL WALL AND THE SEGMENT,

PROTRUDING 3" (9.53MM) FROM THE PANEL. THE NINE GROUND LOCKS ON EACH PANEL SHALL BE ABOUT EQUALLY SPACED BETWEEN EACH

OF THE VERTICAL ROOT DEFLECTING RIBS (3 BETWEEN EACH SET OF RIBS, SEE DETAIL "B") -AN INTEGRAL ZIPPER JOINING SYSTEM PROVIDING FOR INSTANT ASSEMBLY BY SLIDING ONE PANEL INTO ANOTHER (SEE DETAIL "C") 2. THE BASIC PROPERTIES OF THE MATERIAL SHALL BE:

TEST	ASTM TEST METHOD	VALUE COPOLYMER
		POLYPROPYLENE
TENSILE STRENGTH @ YIELD-WALL	D638	2.383 PSI
TENSILE STRENGTH @ YIELD-HINGE	D638	2.483 PSI
YIELD ELONGATION-WALL	D638	7.71%
YIELD ELONGATION-HINGE	D638	7.58%
FLEXURAL MODULUS	D790B	120.785 PSI
NOTCHED IZOD IMPACT-WALL	D256A	2.54 (FT-LBS)
ROCKWELL HARDNESS R. SCALE-WALL	D785A	84.1

B. CONSTRUCTION AND INSTALLATION

1. THE CONTRACTOR SHALL INSTALL THE TREE ROOT BARRIERS WITH THE NUMBER OF PANELS AND IN THE MANNER SHOWN ON THE DRAWINGS. THE VERTICAL ROOT DEFLECTING RIBS SHALL BE FACING INWARDS TO THE ROOT BALL AND THE TOP OF THE DOUBLE EDGE SHALL BE ½" (12.7MM) ABOVE GRADE. EACH OF THE REQUIRED NUMBER OF PANELS SHALL BE CONNECTED TO FORMA CIRCLE AROUND THE ROOT BALL OR JOINED IN A LINEAR FASHION AND PLACED ALONG THE ADJACENT HARDSCAPE.

INSTALL 20 LF OF TREE ROOT BARRIER ON THE SIDEWALK AND CURB SIDE OF ALL

TREE ROOT BARRIER (18" DEEP) SHALL BE PRODUCT #UB 18-2 AS MANUFACTURED

2. EXCAVATION AND SOIL PREPARATION SHALL CONFORM TO THE DRAWINGS.

L2.3 NOTES:

1. INSTALLATION TO BE COMPLETED IN ACCORDANCE TO MANUFACTURER'S SPECIFICATIONS.

TREE ROOT BARRIER -BID ALTERNATE

- 3. REFER TO PRODUCTS: 18 INCH DEEPROOT TREE ROOT BARRIERS, UB 18-2 DETAILS FOR DETAILS.

TREES WITHIN 10'-0" OF HARDSCAPE, CENTER ON TREE.

BY DEEP ROOT PARTNERS (800.458.7668) OR APPROVED EQUAL.

REFERENCE NUMBER 095-003A

DETAIL "A" PATENTED ZIPPER (1.52MM) JOINING SYSTEM PATENTED DOUBLE TOP EDGE FOR PREVENTION OF ROOT OVER (2.03MM)GROWTH, EXTRA STRENGTH, (12.7MM) ULTRAVIOLET PROTECTION AND IMPROVED APPEARANCE (SEE DETAIL "A") DEEPROOT NAME ON EVERY PANEL U.S. PATENT NOS. -5,070,642 OR 5,305,549 AND 5,528,877 OTHER PATENTS PENDING 90° ROOT DEFLECTING RIBS INTEGRAL PART PF PANEL PANEL 0.080" (2.03MM) THICK DETAIL "B" POST CONSUMER RECYCLED POLYPROPYLENE PATENTED MOLDED GROUND LOCKING ANTI-LIFT TABS (SEE DETAIL "B") ROUNDED EDGES FOR SAFETY AND STRENGTH

1. INSTALLATION TO BE COMPLETED IN ACCORDANCE WITH MANUFACTURER'S SPECIFICATIONS. 2. REFERENCE NUMBER 095-003B

A. CURB AND GUTTER

Typical section of curb and gutter with DeepRoot Tree

Vertical ribs face toward tree roots.

- toward tree roots.
- the outside of the form.)


B. SIDEWALK


Typical section of sidewalk with DeepRoot Tree Root Guide inset into concrete.

Guide is installed in a trench in subgrade which is then compacted. Guide is set so that top edge will be 2" (5cm) above compacted rock, gravel or sand (or halfway between rock and finish grade of SW). Vertical ribs face toward tree roots.

INSTALLATION INSTRUCTIONS:

- 1. Prepare base and subgrade. 2. Trench to appropriate depth for installation of root guide so that top of guide is 2" (5cm) below finish grade of sidewalk (or halfway between top of compacted rock and finish grade of SW).
- 3. Place tree root guide in trench. Vertical ribs must face toward tree roots.
- 4. Backfill and compact to requirements.
- 5. Place form material against guide. (It may be nailed from the outside of the form.)

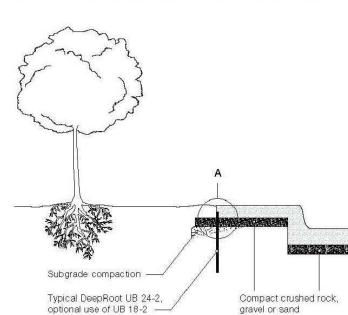

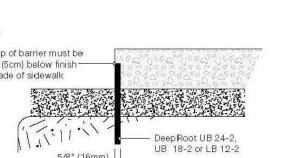




Root Guide inset into concrete.

Guide is installed in a trench in subgrade which is then compacted. Guide is set so that top edge will be 2" (5cm) below finish grade of curb and set flush with edge of curb.

INSTALLATION INSTRUCTIONS:

- 1. Prepare base and subgrade. 2. Trench to appropriate depth for installation so that top of barrier is 2" (5cm) below finish grade of top of curb.
- 3. Place tree root guide in trench. Vertical ribs must face
- 4. Backfill and compact to requirements.
- 5. Place form material against guide. (It may be nailed from

Top of barrier must be 2" (5cm) below finish grade of curb Compact crushed rock, gravel or sand - Typical DeepRoot UB 24-2, optional use of UB 18-2

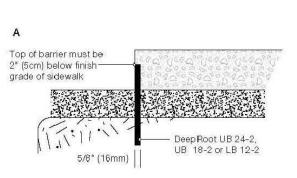

NOT TO SCALE

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Irrigation 5, 81432

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PROJECT NUMBER: DATE 06/28/2019 DESIGNED: WC, CW DRAWN: CW

CHECKED: WC **REVISIONS:**

JOB DESCRIPTION: 90% Construction


SHEET TITLE: ROOT BARRIER

Documents

DETAIL

SHEET NUMBER:

SCALE: AS SHOWN

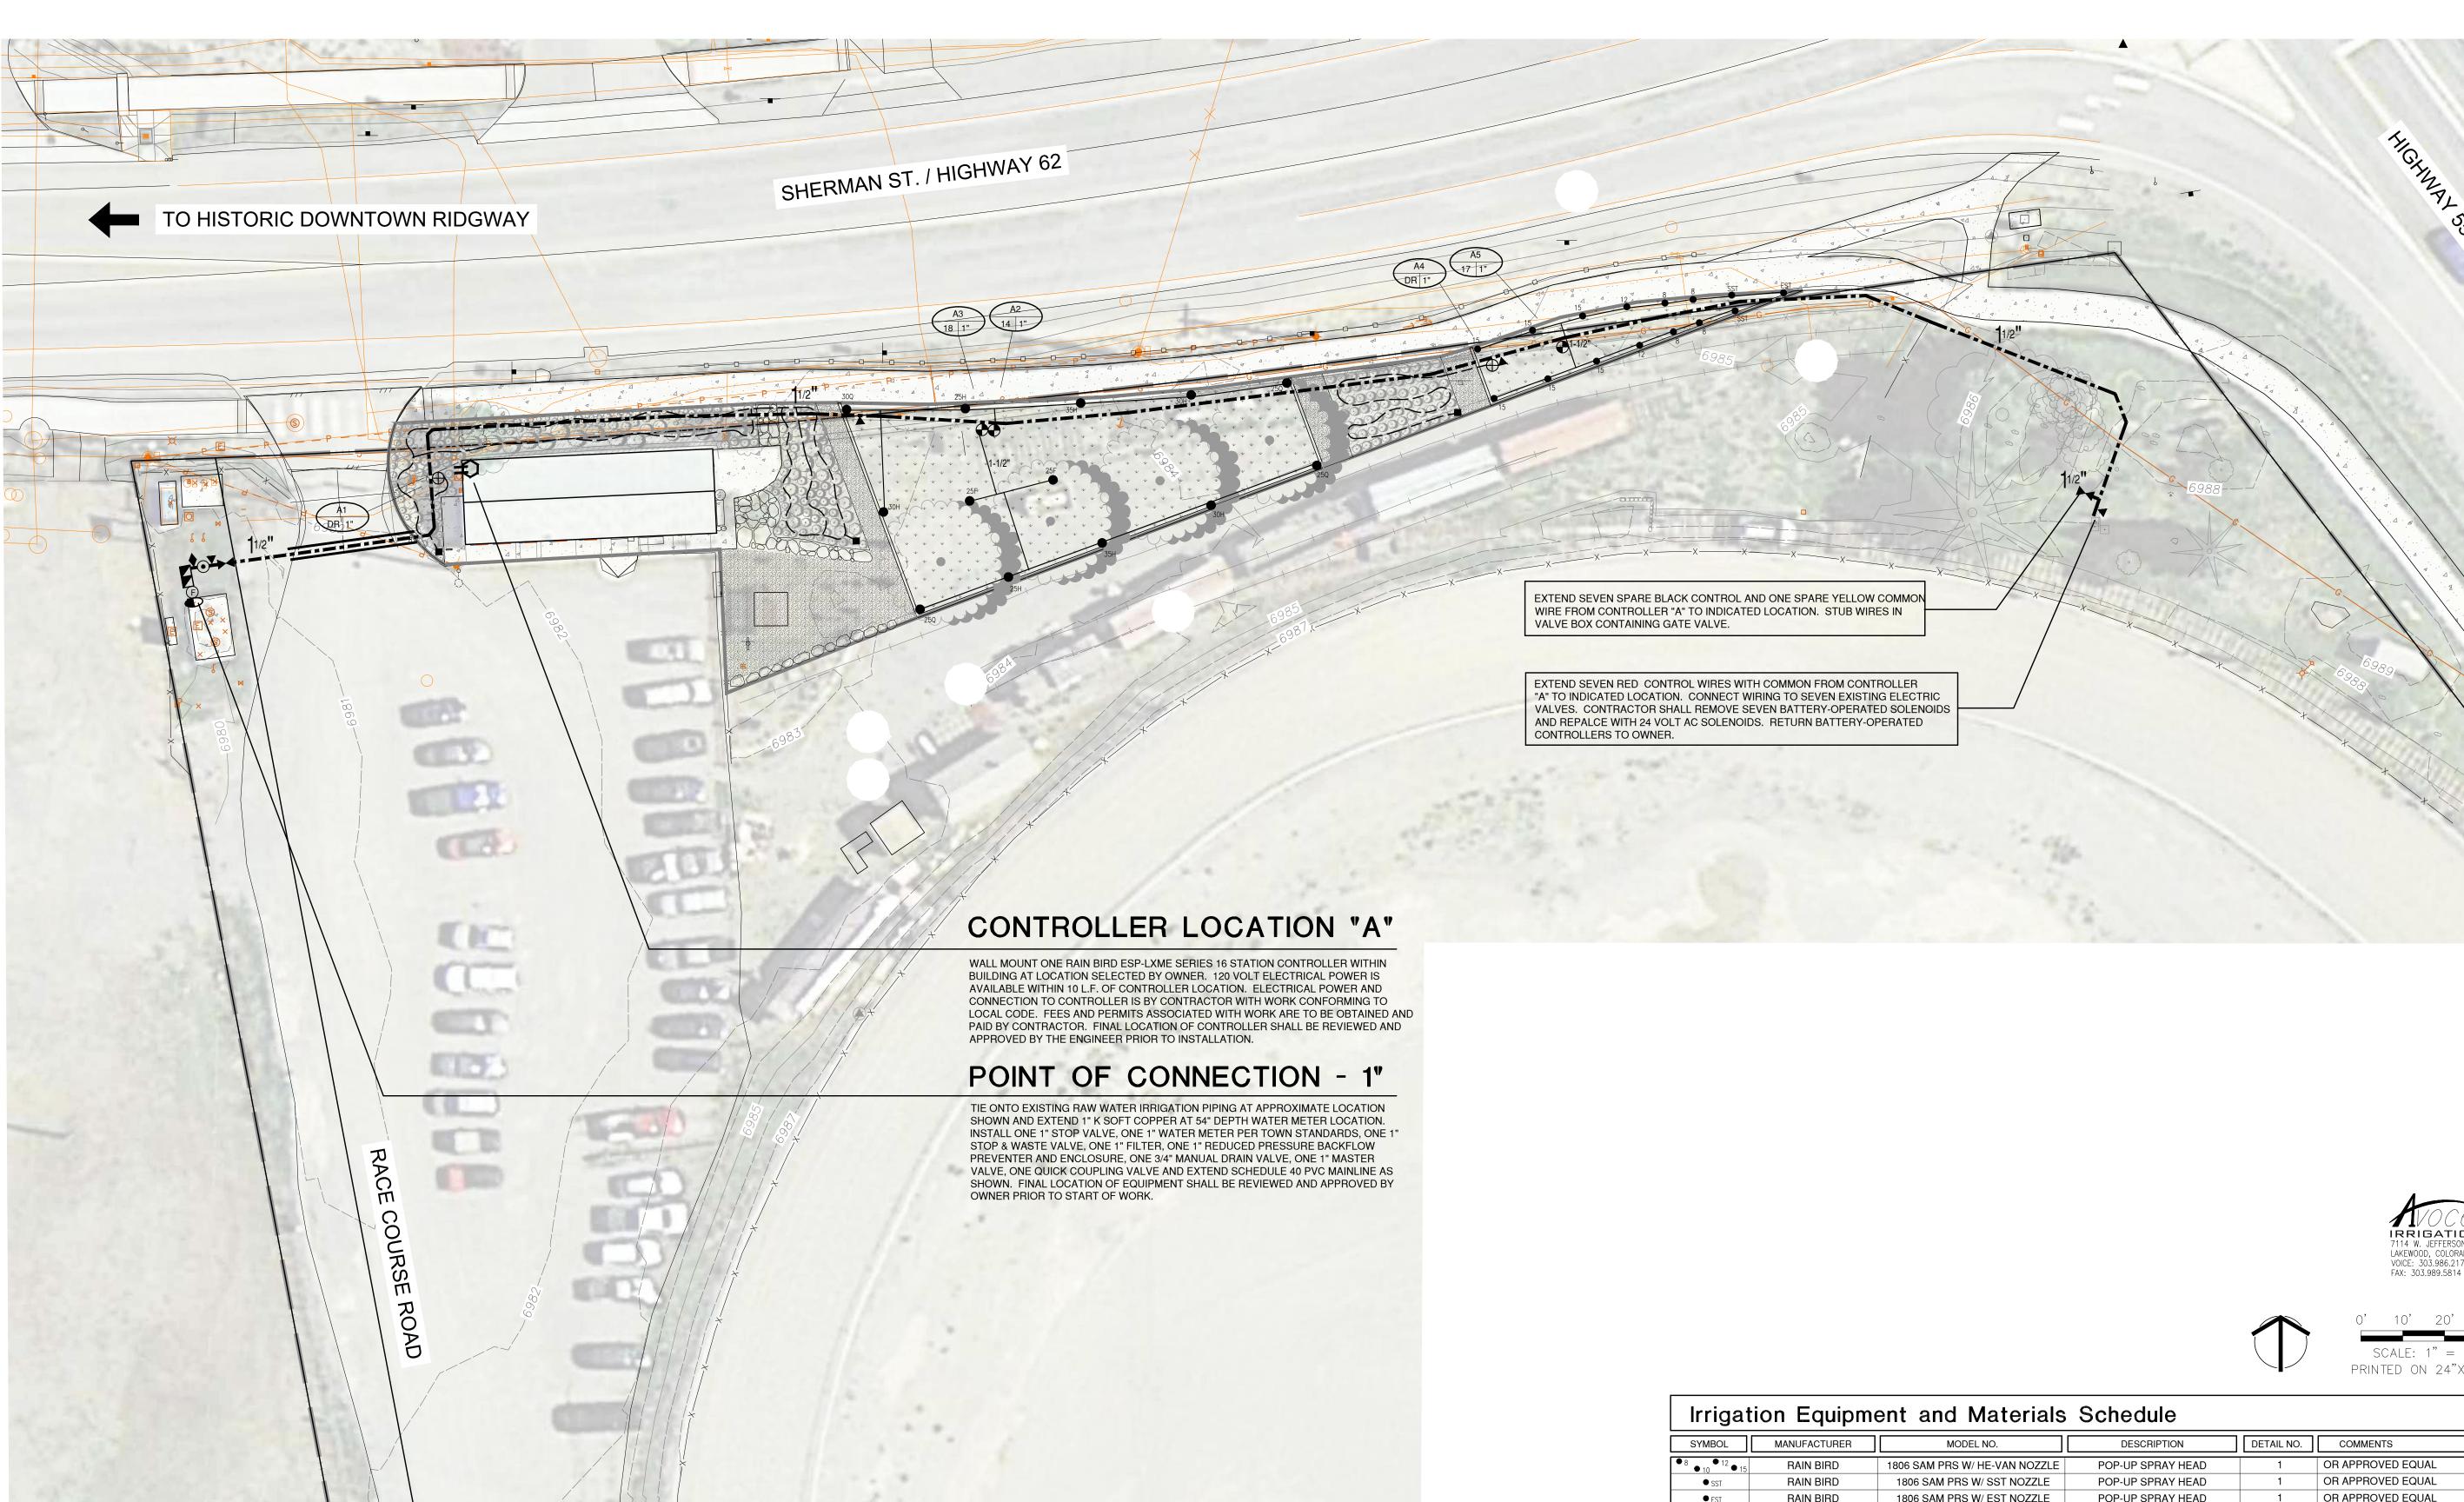



SCALE: 1" = 20'-0" PRINTED ON 24"X36" SHEET

SYMBOL	MANUFACTURER	MODEL NO.	DESCRIPTION	DETAIL NO.	COMMENTS
⁸ • 10 • 12 • 15	RAIN BIRD	1806 SAM PRS W/ HE-VAN NOZZLE	POP-UP SPRAY HEAD	1	OR APPROVED EQUAL
● SST	RAIN BIRD	1806 SAM PRS W/ SST NOZZLE	POP-UP SPRAY HEAD	1	OR APPROVED EQUAL
● EST	RAIN BIRD	1806 SAM PRS W/ EST NOZZLE	POP-UP SPRAY HEAD	1	OR APPROVED EQUAL
25Q 25H 25F	RAIN BIRD	5006-PL-SAM W/ 25 MPR NOZZLE	GEAR DRIVEN ROTOR	2	OR APPROVED EQUAL/RED NOZZLE
30Q ●30H ●30F	RAIN BIRD	5006-PL-SAM W/ 30 MPR NOZZLE	GEAR DRIVEN ROTOR	2	OR APPROVED EQUAL/GREEN NOZZLE
35Q ●35H ●35F	RAIN BIRD	5006-PL-SAM W/ 35 MPR NOZZLE	GEAR DRIVEN ROTOR	2	OR APPROVED EQUAL/TAN NOZZLE
M		LINE DIA.	GATE VALVE	7	
F	RAIN BIRD	LCRBY100D - 1"	IN-LINE FILTER	11	
	MUELLER	ORISEAL H-10284 - 1"	STOP & WASTE VALVE	10	OR APPROVED EQUAL
M		1"	IRRIG. WATER METER	10	
	FEBCO	825YA - 1"	BACKFLOW PREVENTER W/ FILTER	10 & 11	OR APPROVED EQUAL
0	RAIN BIRD	ESP-LXME	ELECTRIC CONTROLLER	12	OR APPROVED EQUAL/ W/ STRONGBOX EN
▼	RAIN BIRD	44 NP	QUICK COUPLING VALVE	5	
•	RAIN BIRD	PES-B SERIES	ELECTRIC CONTROL VALVE	4	OR APPROVED EQUAL
•	RAIN BIRD	PES-B SERIES - 1" DIA.	MASTER VALVE	6	OR APPROVED EQUAL
		SCHEDULE 40 SOLVENT WELD	PVC MAINLINE	9	
		SCHEDULE 40 SOLVENT WELD	PVC IRRIGATION SLEEVING	-	
		SCHEDULE 40 SOLVENT WELD - 1" DIA. UNLESS NOTED OTHERWISE	PVC LATERAL PIPING	9	
		LINE DIA.	DRIP BLOW-OUT STUB	13	
\oplus	RAIN BIRD	XCZ-100-PRB-COM	DRIP VALVE ASSEMBLY	3	
	RAIN BIRD	XBS-940	POLY DRIP TUBING	14	

- CONTROL VALVE SIZE

Irrigation 5, 81432 D D e an andscape a Ridgway Phase 1 - 90% 150 Racecourse Ro

19198.00

DESIGNED: DZ

DRAWN: **DZ** CHECKED: **DZ**

90% Construction


IRRIGATION PLAN

CALE: 1" = 20' - 0"


Documents

06/28/2019


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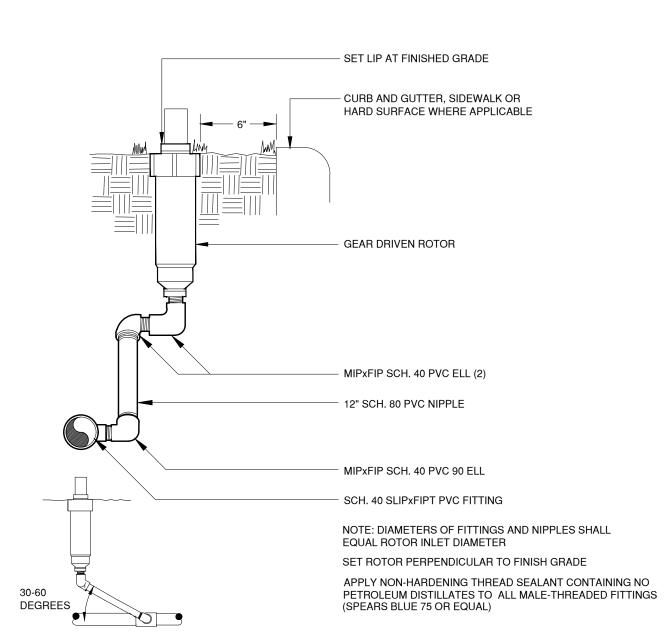


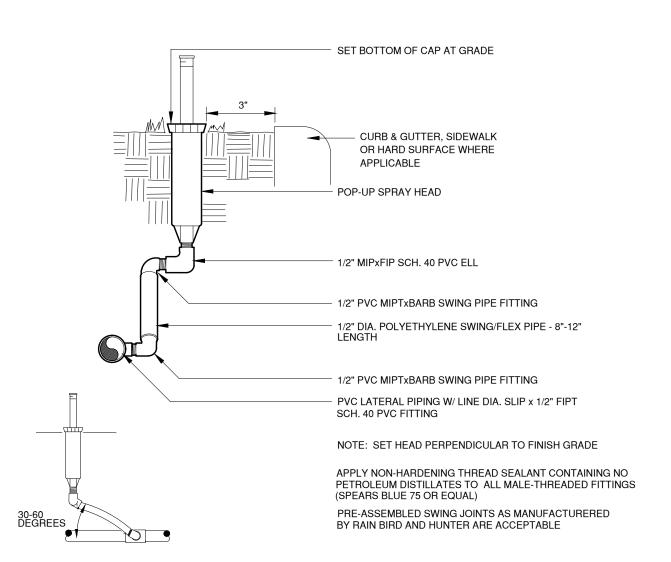POP-UP SPRAY HEAD

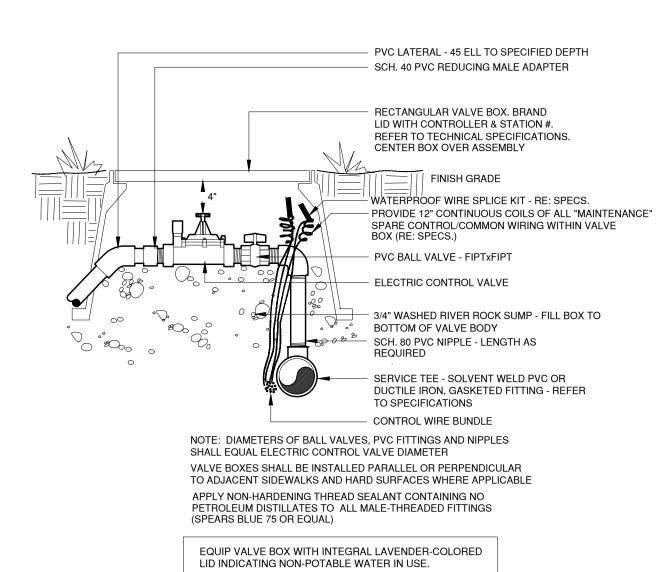


ELECTRIC CONTROL VALVE




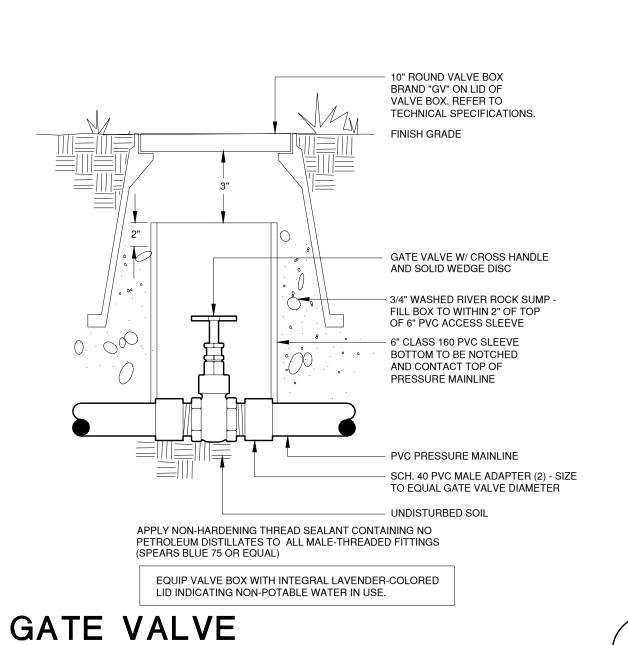

GEAR DRIVEN ROTOR

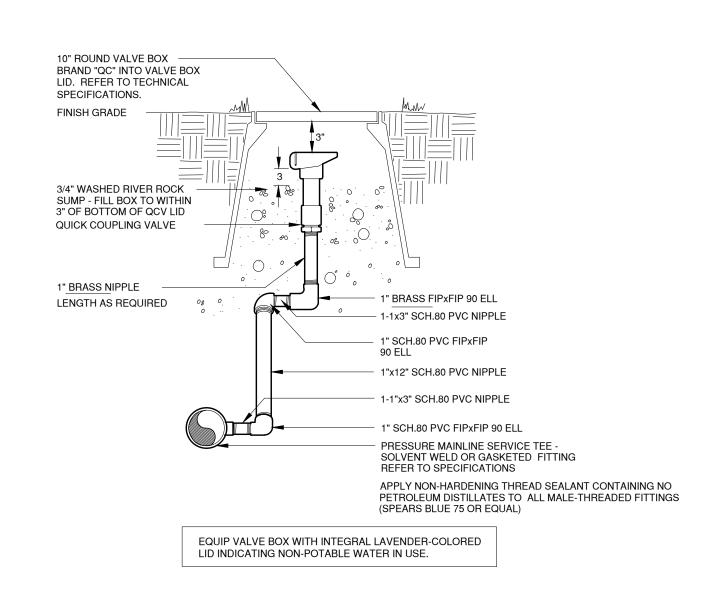

QUICK COUPLING VALVE

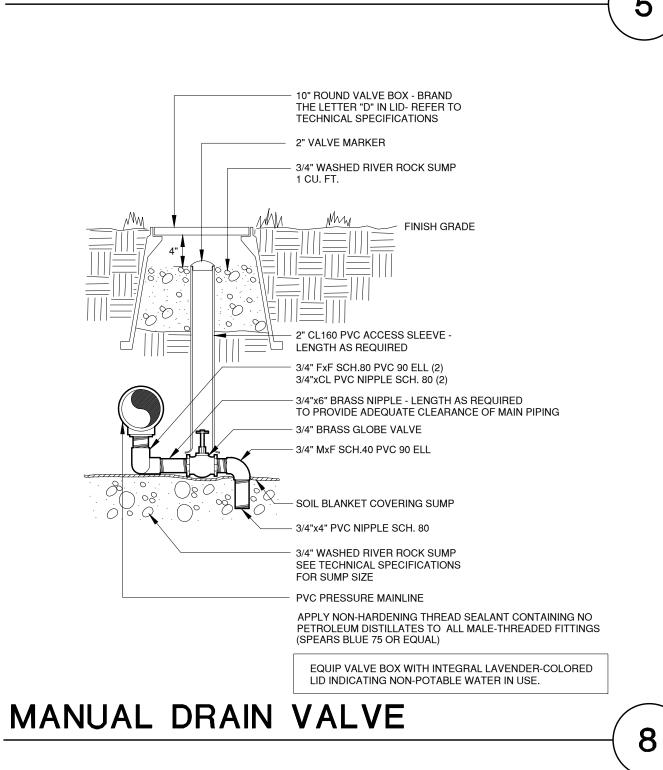


1" POLYETHYLENE DRIP SUPPLY PIPING TO FIRST TEE LOCATION STAINLESS STEEL WORM GEAR CLAMP & 1" INSXMIPT ADAPTER 1" SCH. 40 FxF COUPLING AND INSERTXMIPT ADAPTER RECTANGULAR VALVE BOX. BRAND BOX LID WITH CONTROLLER & STATION NUMBER. REFER TO TECHNICAL SPECIFICATIONS. CENTER BOX OVER ASSEMBLY RAIN BIRD 1" PRB-QKVCHK-100 BASKET FILTER W/ 200 MESH SCREEN PROVIDE 12" CONTINUOUS COILS OF ALL SPARE CONTROL AND COMMON WIRING WITHIN VALVE BOX (RE: SPECS.) 1" SCH. 40 PVC BALL VALVE (FxF) W/ TWO 1"x2" SCH. 80 PVC RAIN BIRD 1" PES-B CONTROL VALVE 1" SCH. 80 PVC NIPPLE - LENGTH AS SERVICE TEE - SOLVENT WELD PVC OR DUCTILE IRON, GASKETED FITTING - REFER TO SPECIFICATIONS CONTROL WIRE BUNDLE 3/4" WASHED RIVER ROCK SUMP - FILL BOX TO

EQUIP VALVE BOX WITH INTEGRAL LAVENDER-COLORED


LID INDICATING NON-POTABLE WATER IN USE.

INSTALL ASSEMBLY TO REST ON GRAVEL SUMP. CONTAIN ENTIRE ASSEMBLY WITHIN BOX. NO VALVE BOX EXTENSIONS WILL BE ACCEPTED PROVIDE 2" MIN. CLEARANCE BETWEEN TOP OF FILTER AND BOTTOM OF BOX LID TOP OF VALVE BOX TO BE FLUSH WITH FINISH GRADE VALVE BOX SHALL NOT REST ON DRIP TUBING/PIPING APPLY NON-HARDENING THREAD SEALANT CONTAINING NO PETROLEUM DISTILLATES TO ALL MALE-THREADED FITTINGS (SPEARS BLUE 75 OR EQUAL)

DRIP VALVE ASSEMBLY

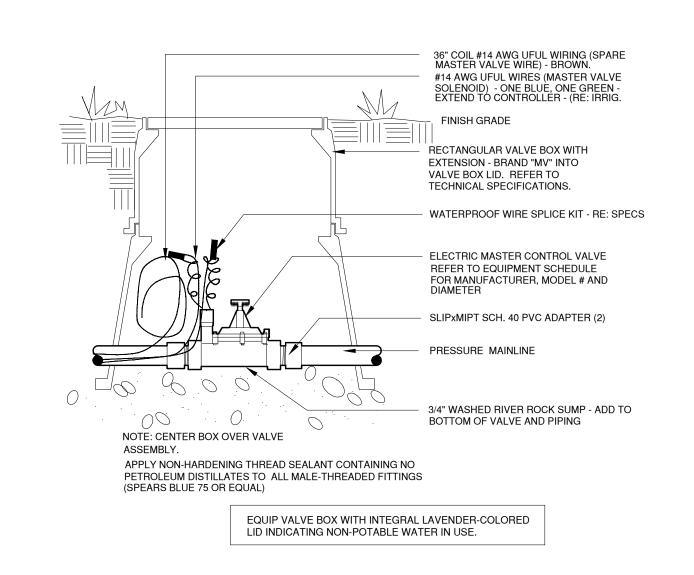

MASTER VALVE

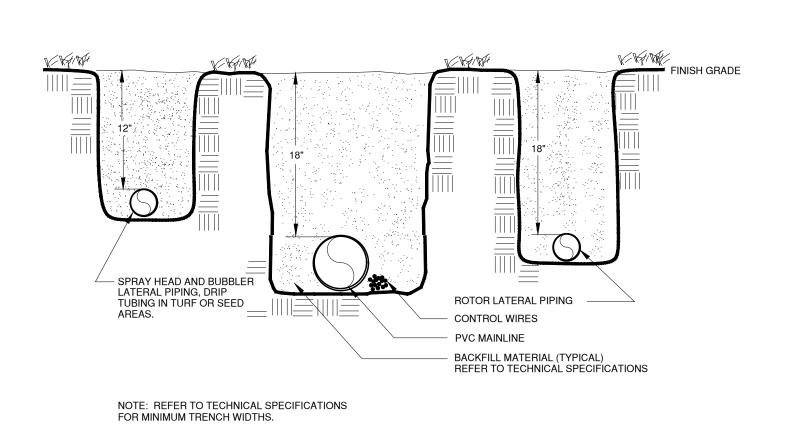

TRENCH

Irrigation Construction Notes

2. REFER TO TECHNICAL SPECIFICATIONS AND CONSTRUCTION DETAILS FOR

3. CONTRACTOR SHALL FIELD VERIFY PRESSURE AT BACKFLOW PREVENTER LOCATION FOR EACH TAP PRIOR TO ORDERING MATERIALS OR STARTING ANY IRRIGATION INSTALLATION AND NOTIFY CONSULTANT OF ANY DIFFERENCES FROM STATED PRESSURE. IF CONTRACTOR FAILS TO NOTIFY CONSULTANT HE ASSUMES FULL RESPONSIBILITY FOR ANY SYSTEM ALTERATIONS. EACH SYSTEM HAS BEEN DESIGNED FOR A STATIC PRESSURE OF 90 PSI (PER TOWN).

4. CONTRACTOR SHALL COORDINATE INSTALLATION OF SLEEVING WITH INSTALLATION OF CONCRETE FLATWORK AND PAVING. ALL SLEEVING IS BY CONTRACTOR UNLESS OTHERWISE NOTED. UNLESS NOTED OTHERWISE ON IRRIGATION PLANS INSTALL SLEEVING BASED ON SLEEVE SIZING GUIDE BELOW:

PIPE SIZE OR WIRE QUANTITY 3/4" - 1" PIPING 1-1/2" - 2" PIPING 1-25 CONTROL WIRES

- 5. WHERE NOT NOTED ON IRRIGATION PLANS CONTRACTOR TO INSTALL PLASTIC 15 SERIES NOZZLES ON POP-UP SPRAY HEADS SPACED GREATER THAN 12 FEET. INSTALL 12 SERIES NOZZLES ON POP-UP SPRAY HEADS SPACED 10-12 FEET. INSTALL 10 SERIES NOZZLES ON ALL POP-UP SPRAY HEADS SPACED 8-10 FEET. INSTALL 8 SERIES NOZZLES ON POP-UP SPRAY HEADS SPACED 8 FEET AND LESS.
- 7. CONTRACTOR SHALL REPAIR OR REPLACE ANY EXISTING IRRIGATION EQUIPMENT, TURF, PLANT MATERIAL OR SITE FEATURES DAMAGED DURING NEW INSTALLATION. REPLACEMENT OR REPAIR OF DAMAGED EQUIPMENT OR MATERIAL SHALL BE DETERMINED BY THE OWNER AND THE CONSULTANT.
- 9. REFER TO IRRIGATION TECHNICAL SPECIFICATIONS FOR PLANTING AND IRRIGATION LAY-OUT REQUIREMENTS, COORDINATION AND PRIORITIES.
- 10. LATERAL PIPING DIAMETERS SHALL INCLUDE 1". 3/4" AND 1 1/4" DIAMETER LATERAL PIPE IS NOT ACCEPTABLE.

ALL IRRIGATION PIPING AND WIRING UNDER WALKS AND STREETS SHALL BE INSTALLED WITHIN SLEEVES.


1. ALL BASE INFORMATION HAS BEEN TAKEN FROM DRAWINGS PREPARED BY DHM

INSTALLATION PROCEDURES.

REQUIRED SLEEVE 1-2" PVC SLEEVE 1-4" PVC SLEEVE 1-2" PVC SLEEVE

NOTE: EACH LENGTH OF SLEEVED PIPE SHOWN SHALL BE ROUTED THROUGH SEPARATE SLEEVE. IRRIGATION WIRE BUNDLE SHALL BE ROUTED IN SEPARATE SLEEVE/CONDUIT WITHOUT IRRIGATION PIPING

- REFER TO PLANTING PLAN FOR EXACT TREE LOCATIONS AND QUANTITIES, TREES SHOWN ON IRRIGATION PLANS ARE APPROXIMATE.
- 8. VALVE BOXES SHALL BE LOCATED 36" MINIMUM FROM CENTERLINE OF ALL SWALES, 24" MINIMUM FROM EDGES OF ALL WALKS, CURBS, DRIVES AND OTHER HARD

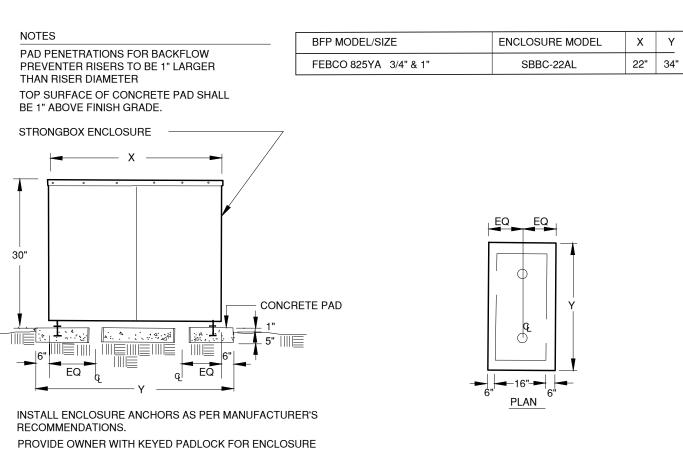

BACKFLOW ENCLOSURE

19198.00 06/28/2019 22" 34" SIGNED: DZ DRAWN: **DZ** DΖ 90% Construction Documents IRRIGATION DETAILS N.T.S.

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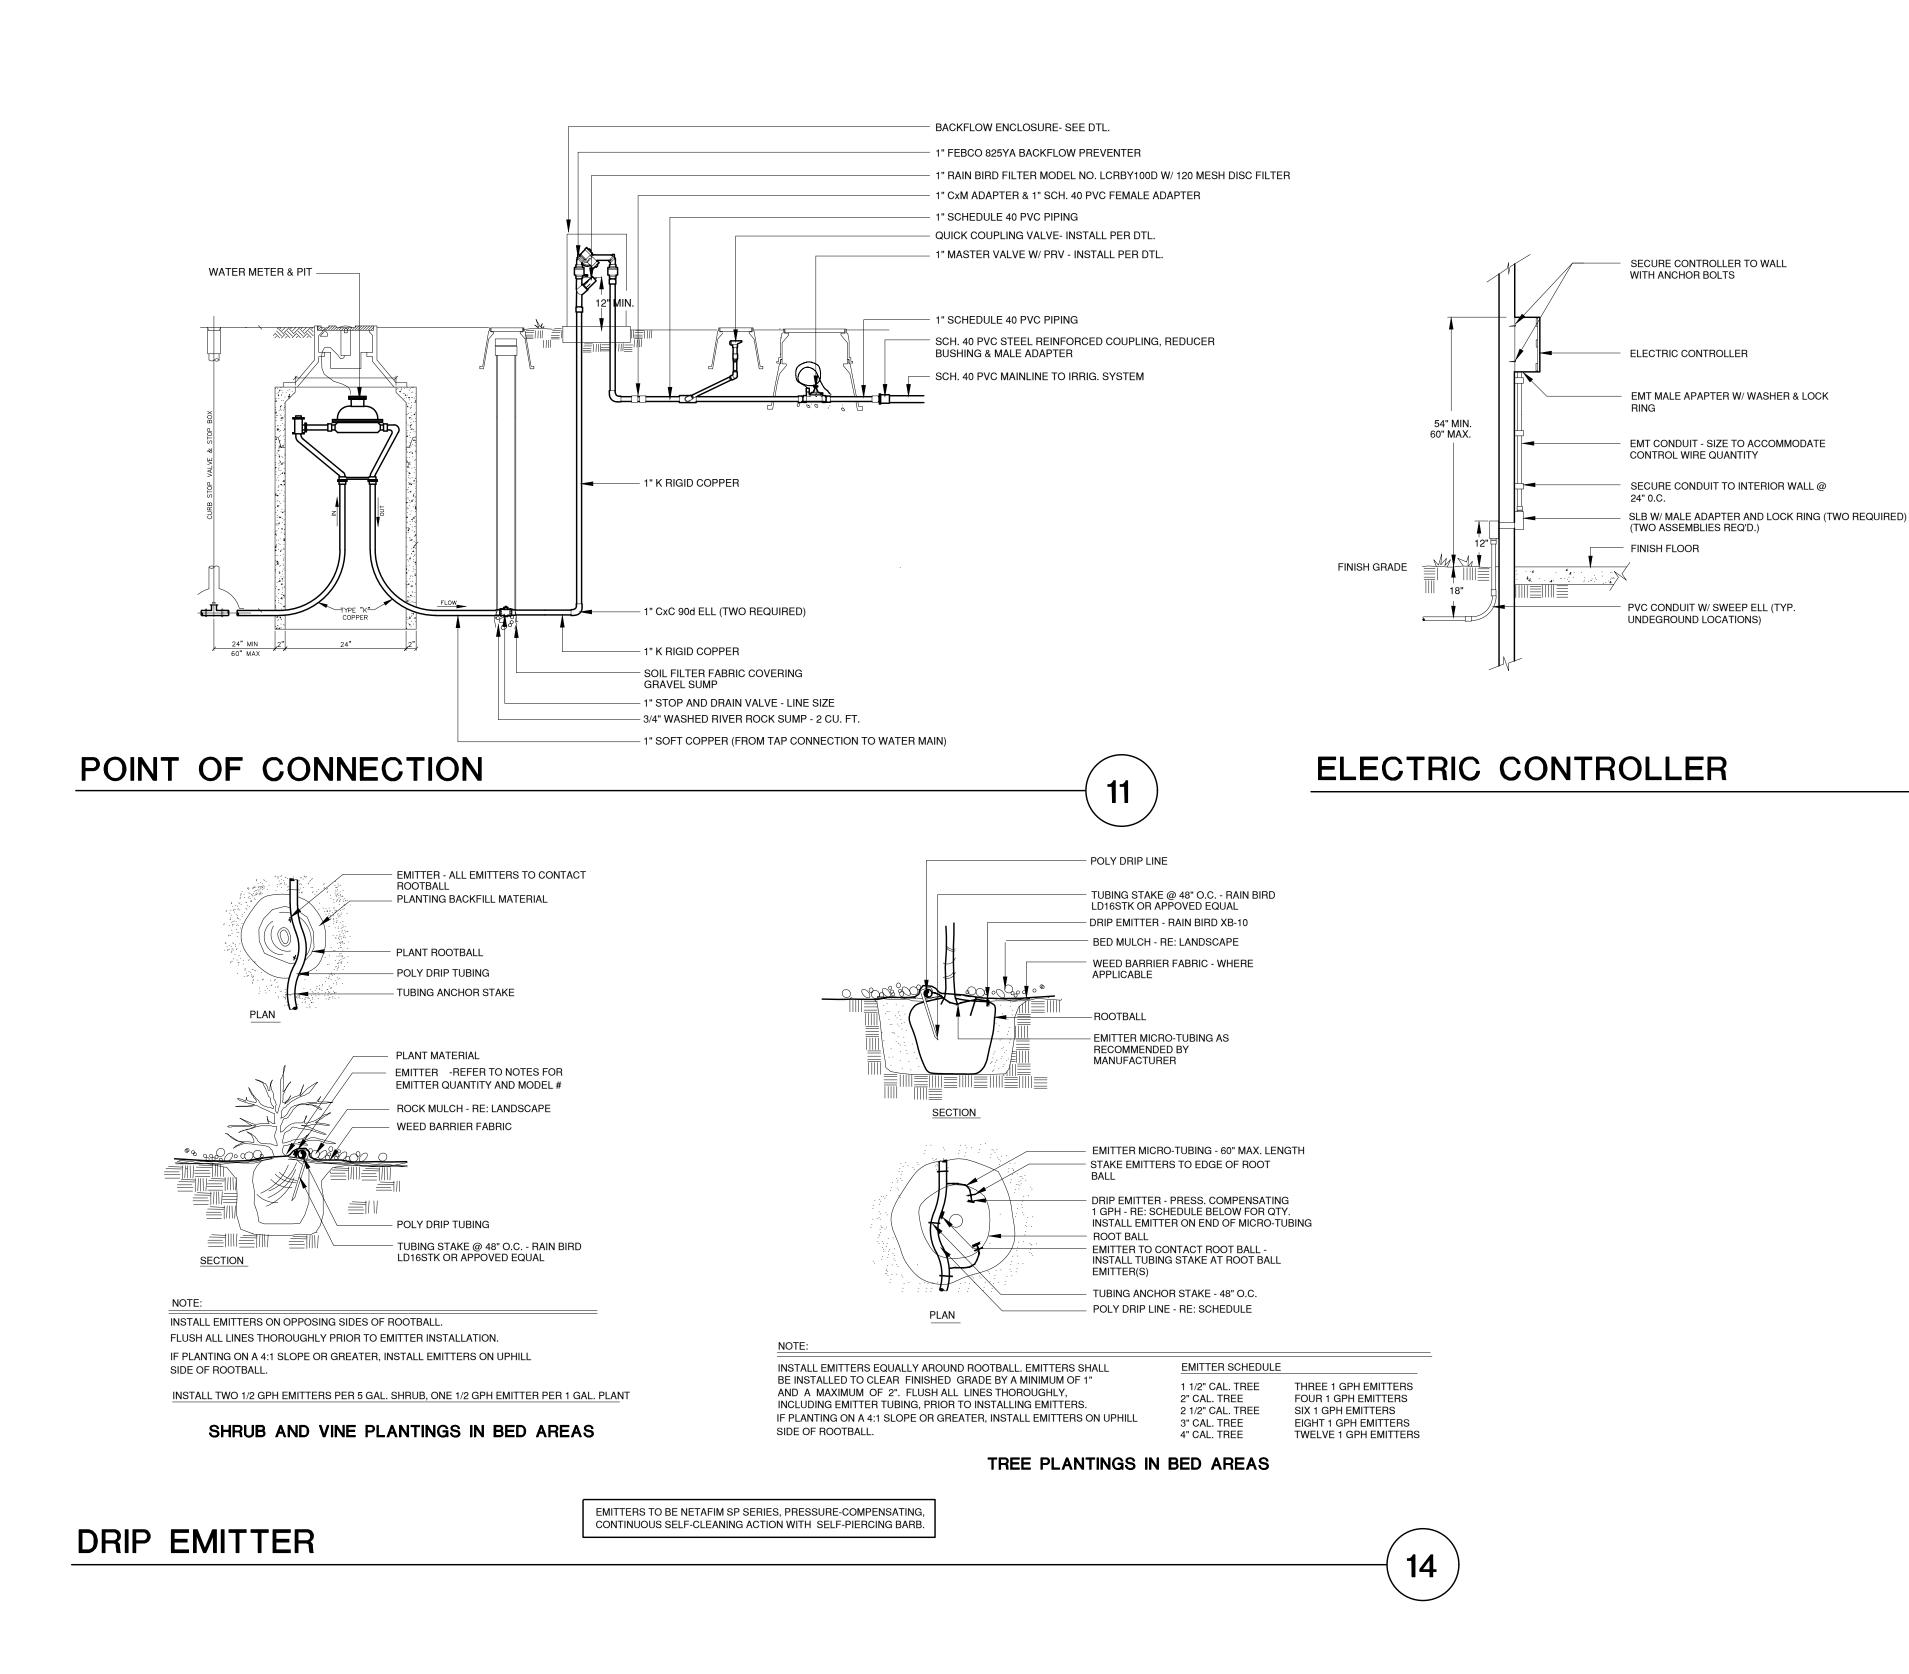
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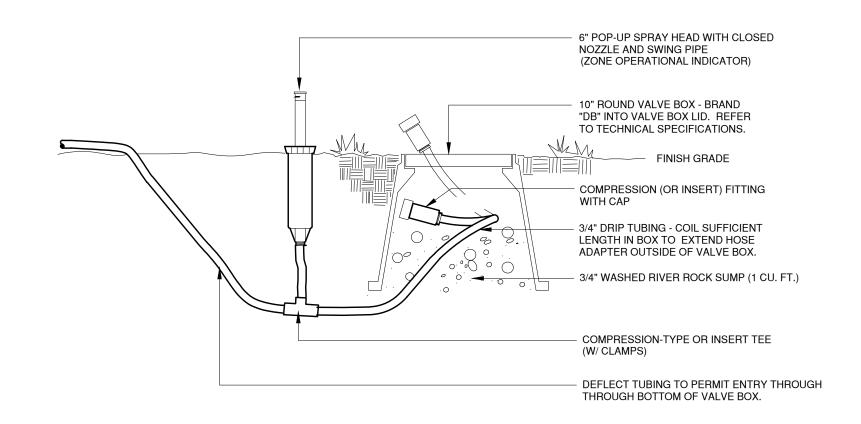
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DRIP LINE FLUSH-OUT AND OPERATIONAL INDICATOR

13

Ridgway Heritage Park
Phase 1 - 90% Landscape and Irrigation CDs
150 Racecourse Road, Ridgway Colorado, 81432

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PROJECT NUMBER: DATE
19198.00 06/28/2019
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90% Construction
Documents

SHEET TITLE:

IRRIGATION DETAILS

11.3

N.T.S.